Architectural_S4.55 Package

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2827.22 DA00	Cover Sheet & Location Plan
2827.22 DA01	Services Basement
2827.22 DA02	Siteworks/Ground Floor Plan
2827.22 DA03	Floor Plan - Level 01
2827.22 DA04	Floor Plan - Level 02
2827.22 DA05	Floor Plan - Level 03
2827.22 DA06	Floor Plan - Level 04
2827.22 DA07	Floor Plan - Level 05
2827.22 DA08	Floor Plan - Level 06
2827.22 DA09	Floor Plan - Level 07
2827.22 DA10	Floor Plan - Roof Terrace
2827.22 DA11	Roof Plan
2827.22 DA12	East Elevation (Charles Street)
2827.22 DA13	North Elevation Mill Road)
2827.22 DA14	West Elevation
2827.22 DA15	South Elevation
2827.22 DA16	Section 01
2827.22 DA17	Section 02
2827.22 DA18	ADG - Soft Landscape & Deep Soil Diagran
2827.22 DA19	ADG - Solar Access Plans
2827.22 DA20	ADG - Cross Ventilation Plans
2827.22 DA21	Shadows - 21 June @ 9am
2827.22 DA22	Shadows - 21 June @ 12 noon
2827.22 DA23	Shadows - 21 June @ 3pm
2827.22 DA24	Fence and Letterbox details
2827.22 DA25	Area Calculation Tables
2827.22 DA26	Photomontage 1
2827.22 DA27	Photomontage 2
2827.22 DA28	Photomontage 3
2827.22 DA29	ADG - Storage area Plans
2827.22 DA30	Proposed Gross Floor Area Plans
2827.22 DA31	Approved Gross Floor Area Plans
2827.22 DA32	Building Footprint Plans
2827.22 DA33	Adaptable(Access) Plan
000T 00 D 10 1	

Landscape Plan Schedule

2827.22 L01 Landscape Plan - Ground Floor & Details

2827.22 DA34 ADG - Approved Area Calculations

SIXT Car & Truck Rental Liverpool

Civil Drawing Schedule

Survey Drawing Schedule

24461 General Details and Site Levels

General Notes

G	eneral Notes
1.	refer to the architectural drawings and specification in conjunction with consultants documentation for the full scope of works.
2.	for all structural elements including steel or reinforced columns,floor slabs, stairs, retaining walls, and roof framing refer to structural
2	engineers drawing and details, u.n.o.

the site boundaries and levels have been established from the survey prepared by Norton Survey Partners... dated 23/04/13......
 building setout and boundary clearance to be verified by a registered surveyor before construction begins and any discrepancies referred to the architect.
 all levels based on assumed datum, u.n.o.

surveyor before construction begins and any discrepancies referred to the architect.

5. all levels based on assumed datum, u.n.o.

6. all construction work to be carried out to comply with the requirements of authorities having jurisdiction over the works, including the conditions of approval issued for the project by the local council and relevant statutory authorities.

7. figured dimensions to be taken in preference to scaling from drawings.

refer to services consultants documents for all relevant services details.
 all works to comply with AS1428.1 & AS1428.4 - Design for access and mobility.
 clear dimensions of required exits including stairs, fire passages and landing and paths of travel to an exit shall be minimum 1 metre wide and minimum 2 metres high.

Electronic Documentation

The electronic copies of Architectural drawings, provided at the Builder's request for assistance in the production of shop drawings are subject to the following conditions:

My Search Heroes

Liverpool Community Centre

Play 2 Learn

Paterson Trailers

Al Am

* these drawings are not contract documents

* the recipient is responsible for any inaccuracies or omissions resulting from faulty electronic transfer of the information

* it remains the Builder's responsibility to provide to sub-contractors all the information they need to carry out the work based on the contract documents including any notices to tenderers, site instructions etc. No responsibility will be accepted by the Architect nor will a variation to the contract be approved for any incomplete or deficient information provided by the Builder to a sub-contractor

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This is an electronic copy of the drawing provided for information only. The contract documents are the hard copy and no guarantee can be provided that the electronic copies as transferred are identical.

		DEVELOPMENT	DATA		
ADDRESS	23-25 Charles Street Street, Liverpool				
SITE AREA	802m2				
NUMBER OF EXISTING LOTS	Lots 1 & 2 DP 500066				
FSR* 0:5 bonus FSR	Max. FSR 1.5:1 + 0.5:1 = 2:1 = (1,604m2) Proposed FSR 2.07:1 (1,662.17m2)				
	Basement	0.00	m2		
	Ground	56.35	m2		
	Level 1	289.11	m2		
	Level 2	288.33	m2		
	Level 3	288.33	m2		
GFA*	Level 4	182.03	m2		
	Level 5	182.09	m2		
	Level 6	182.09	m2		
	Level 7	181.37	m2		
	Roof Terrace	12.47	m2		
	TOTAL	1,662.17	m2		
	*GFA measured to inner	face of external enclosi	ng wall, excluding	lifts, stairs, services & voids.	
	Bedroom No.	TOTAL			
VIELD	1 Bed Unit	12	1		
YIELD	2 Bed Unit	11	1		
	TOTAL	23	1		
NUMBER OF DWELLINGS	Proposed Residential Apa	artment Building (x 23 U	Jnits) + Ground F	loor Parking & Service Basemer	

	Control	Re	equirement	Proposed
BUILDING HEIGHT	LIVERPOOL LEP	Approved	DA RL = RL 48.80	RL 50.52
PARKING	AHSEPP		@ 0.4 space = 4.8 @ 0.5 spaces = 5.5	10 spaces
Bicycles	LIVERPOOL DCP		14	14 spaces
		Front & Secondary(st reet)	Classified Roads = 7m Other Streets = 5.5m	4m
SETBACKS	LIVERPOOL DCP	Side	3m(First 10m in height, excluding roof/attic) & 8m(Greater than 10m in height)	3.02m & 6.02m
		Rear	8m(First 10m in height, excluding roof/attic)	G - L04 = 6m & 3.02m L05 - L07 = 9.02m
LANDSCAPE AREA	ADG	min. 30% of	site area = (240.6m2)	265.34m2 (33% of site area)
DEEP SOIL	ADG	min. 15% of	site area = (120.3m2)	175.02m2 (22% of site area)
COMMON AREA	ADG	minimu	al open space has a um area equal to ne site = (200.5m2)	250.71m2 (32% of site area)
CROSS VENTILATION	ADG	na	% of apartments are turally cross the first nine storeys of ng. (13.8 units)	17 Units (74%)
SOLAR ACCESS	ADG	spaces of apartments	ns and private open s of at least 70% s in a building receive a inimum of 3	Living Areas = 17 Units (74%)
		hours direct	sunlight between 9 am	Private Open Space = 1

Private Open Space = 17 Units(74%)



Corner Mill Road & Charles Street Perspective



Mill Road Perspective



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24/05/23

28/06/23

discrepancies referred to architect for determination. figured dimensions to take precedence over scaled dimensions.

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associates pty limited.

S4.55 SubmissionS4.55 Re Submission

S4.55 Submission in

Response to Panel

S4.55 Submission in
O4 Response to Council
Comments

Meeting





Hume Community Housing

Residential Apartments

23-25 Charles Street, Liverpool, NSW


Drawn; jok Checked; jok Plot date; 1/9/2023

Scale; 1:1, 1:1.000, 1:5.212 as noted @ AI


Project No; 2827.22

Drawing No; Revision#; DA00 04

Cover Sheet & Location Plan

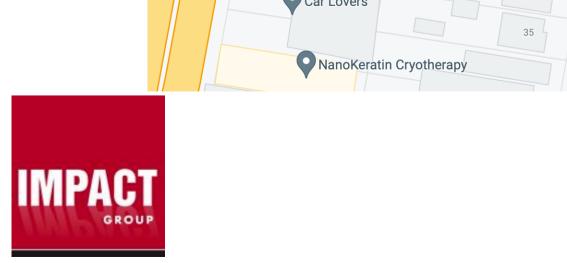

Metal polishing and chroming

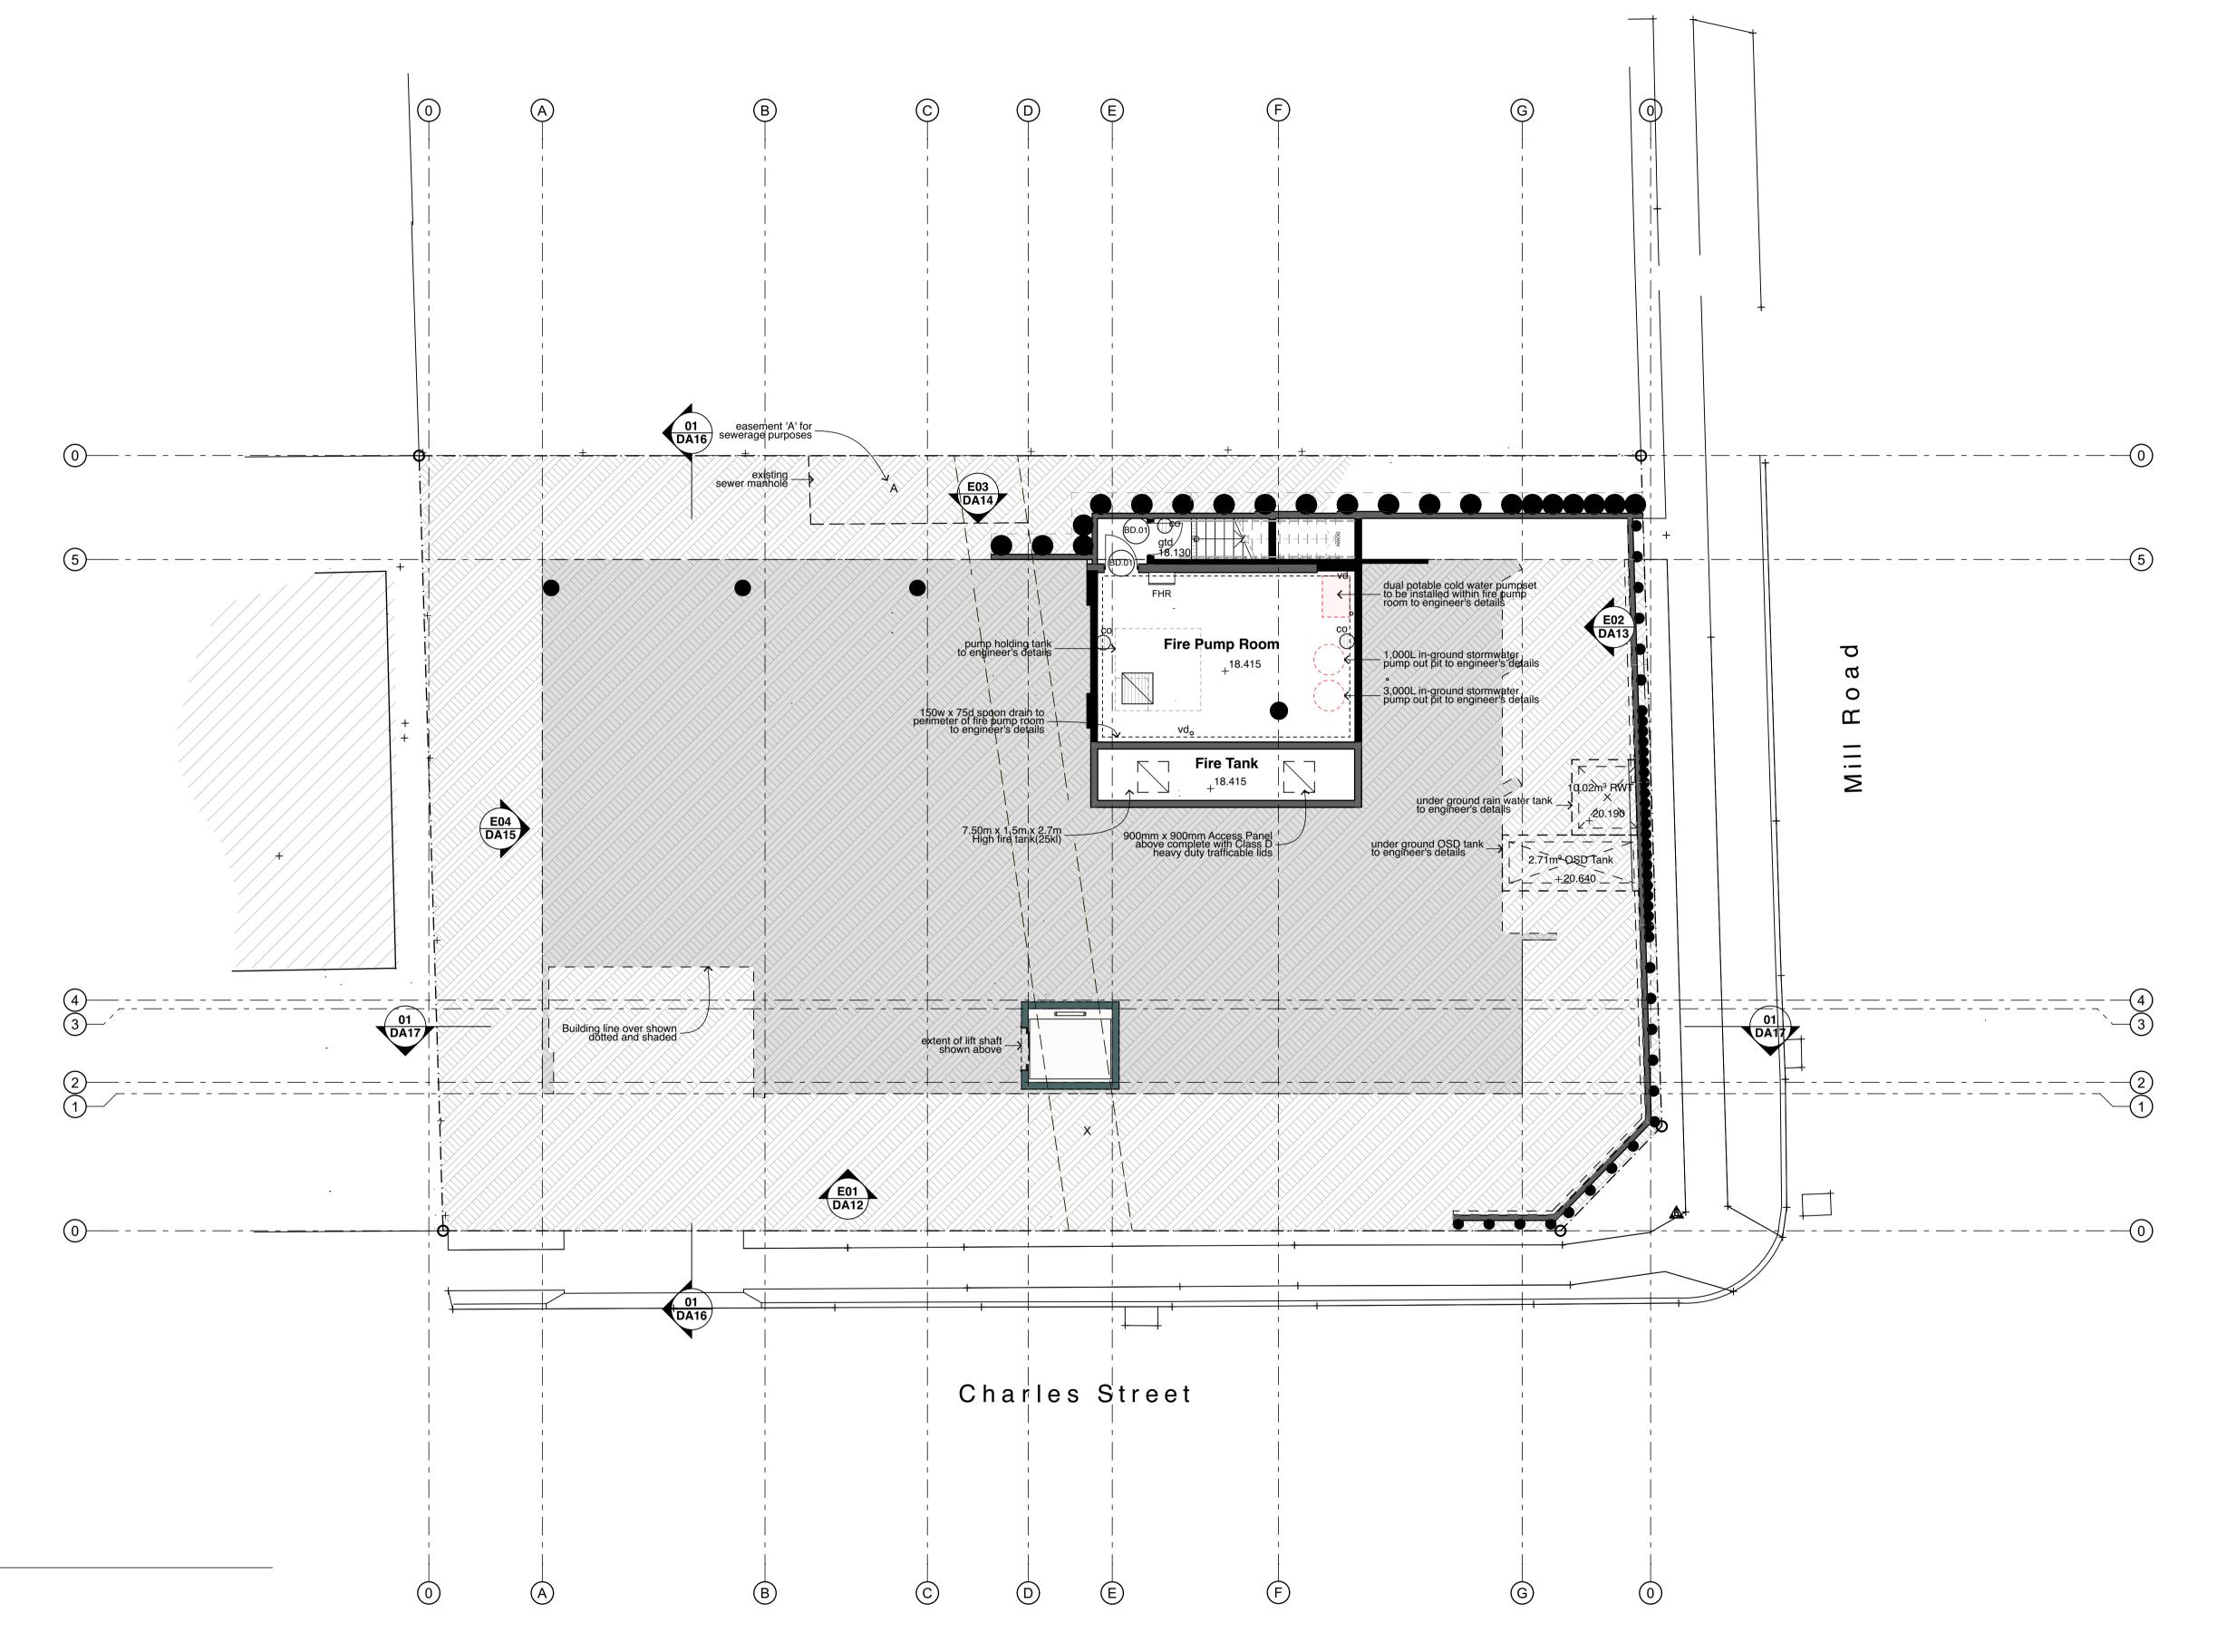

IMPACT GROUP

Services Basement

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02	S4.55 Re Submission	24/05/23
03	S4.55 Submission in Response to Panel Meeting	28/06/23
04	S4.55 Submission in Response to Council Comments	







Hume Community Housing

Residential Apartments

23-25 Charles Street, Liverpool, NSW

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Scale;1:100 as noted @ AI


Project No; 2827.22

Drawing No; DA01

04

Revision#;

Services Basement

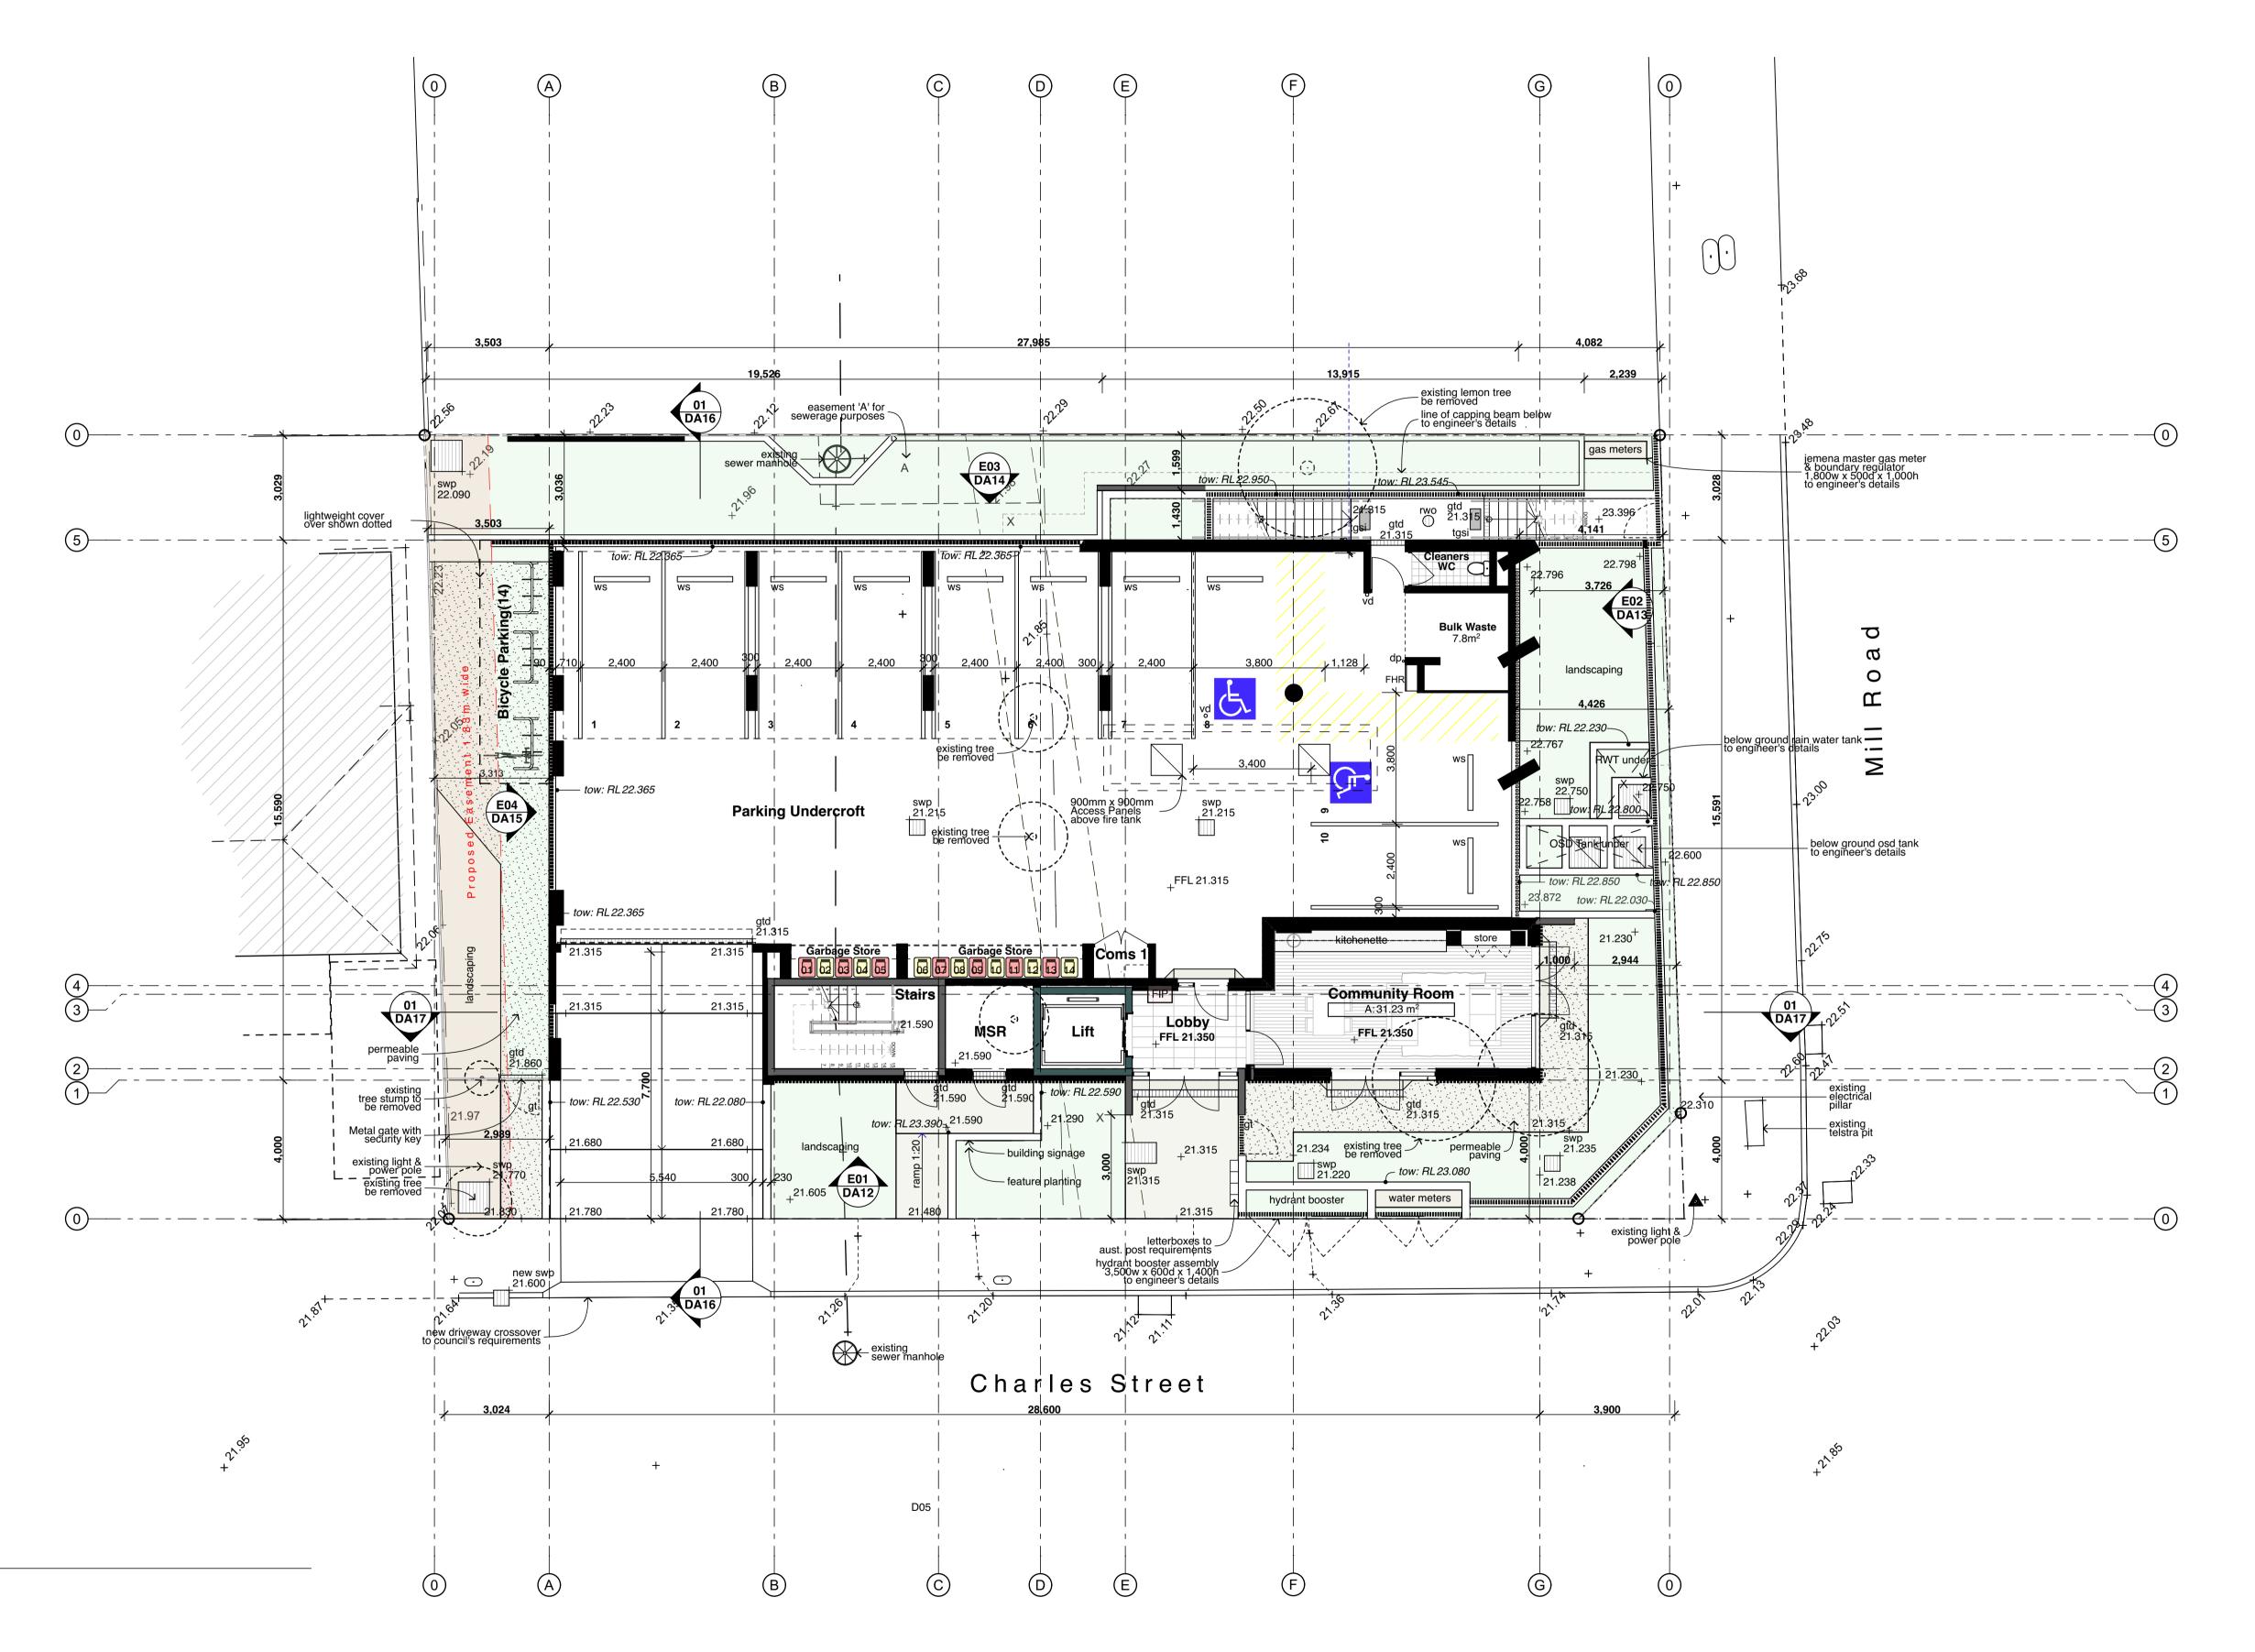





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	Comments	







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Residential Apartments

23-25 Charles Street, Liverpool, NSW

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Project No; 2827.22


Drawing No; DA02

ks/Groun

04

Revision#;

Siteworks/Ground Floor Plan

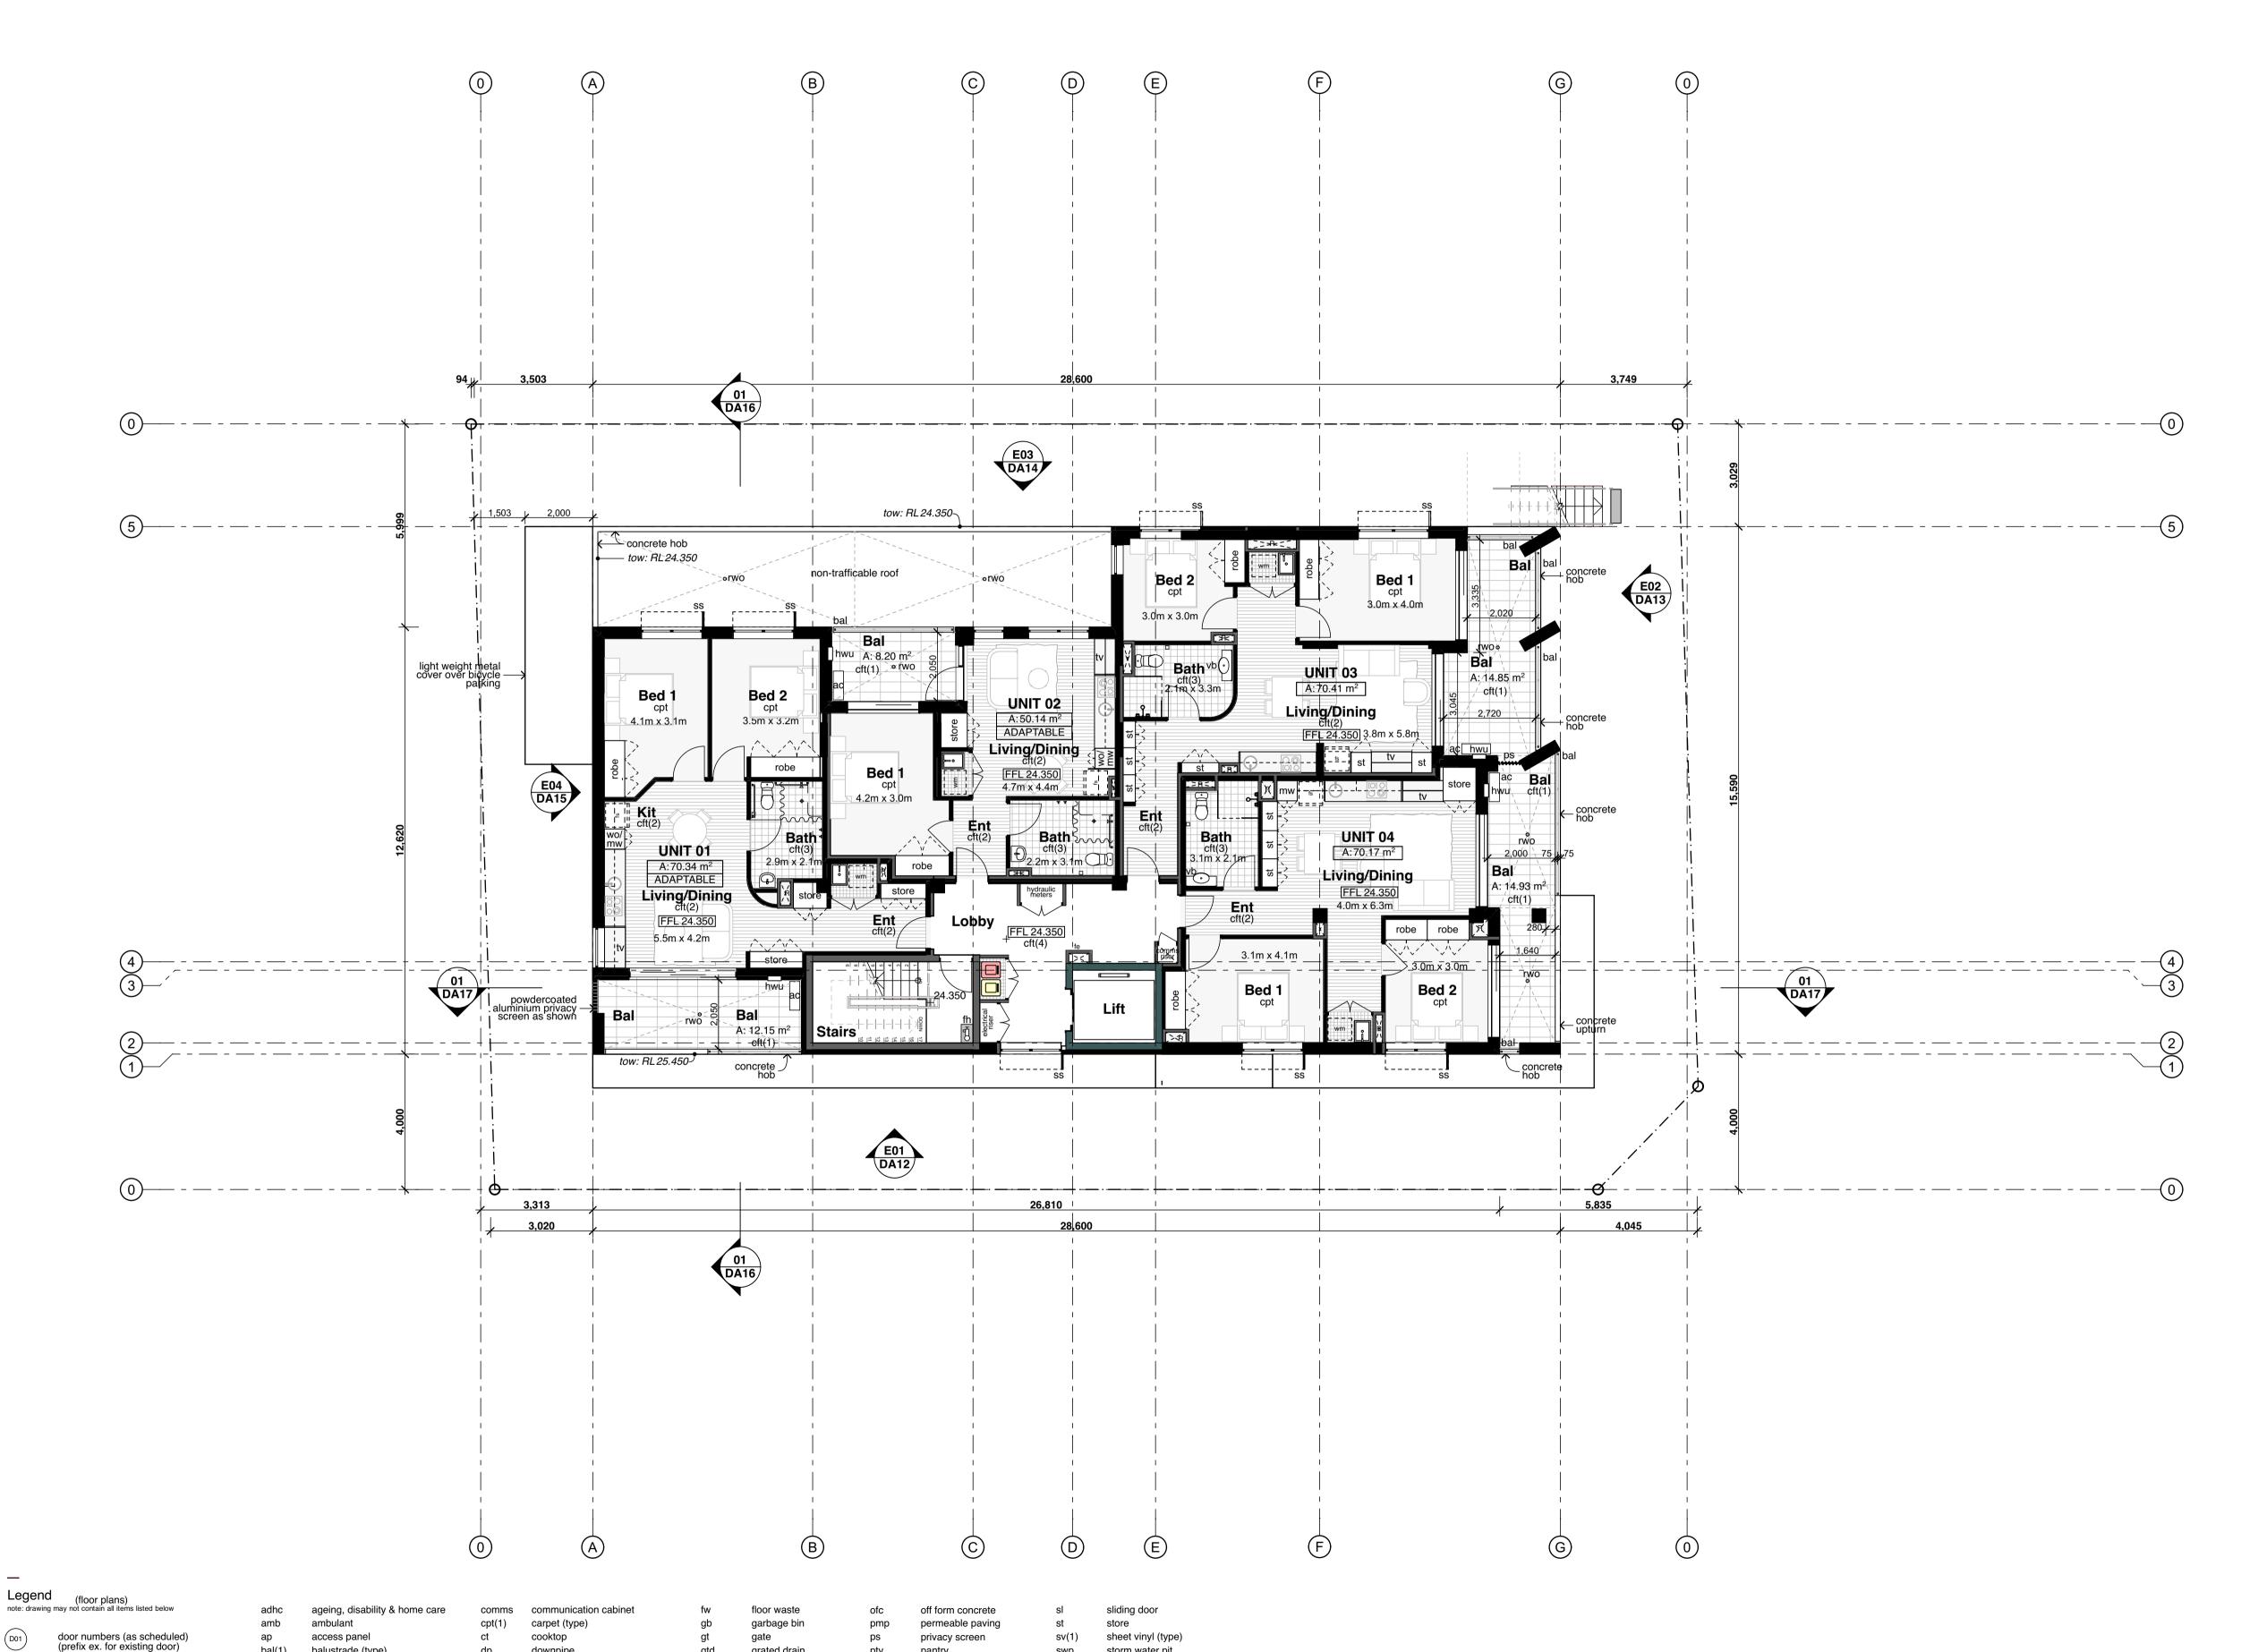

storm water pit

wood float concrete

washing machine space

vent pipe

wall oven

wheel stop

window casing

tactile ground surface indicators

UNIT 06——•Unit number

A:50.00 m² Unit total area

AFFORDABLE - LHA S

Unit type

*LHA S refers to Livable Housing Australia - Silver Level



bal(1)

window numbers (as scheduled)

(prefix ex. for existing window)

wall type (as scheduled)

balustrade (type)

broom cupboard

control joint

clothes line

column

broom finish concrete

ceramic floor tile (type)

downpipe

doorpost

electrical distribution box

face brickwork (type)

fire hose reel

fridge space

floor mat

grated drain

hose tap

hydrant

kerb ramp

letter box

linen cupboard

handrail (type)

hot water unit

robe

wardrobe

steel column

skylight/skytube

shower

retaining wall (type)

steel float concrete

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PO Box 833, Epping, NSW 1710, Australia

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04	Response to Council	
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Hume Community Housing

Residential Apartments

23-25 Charles Street, Liverpool, NSW

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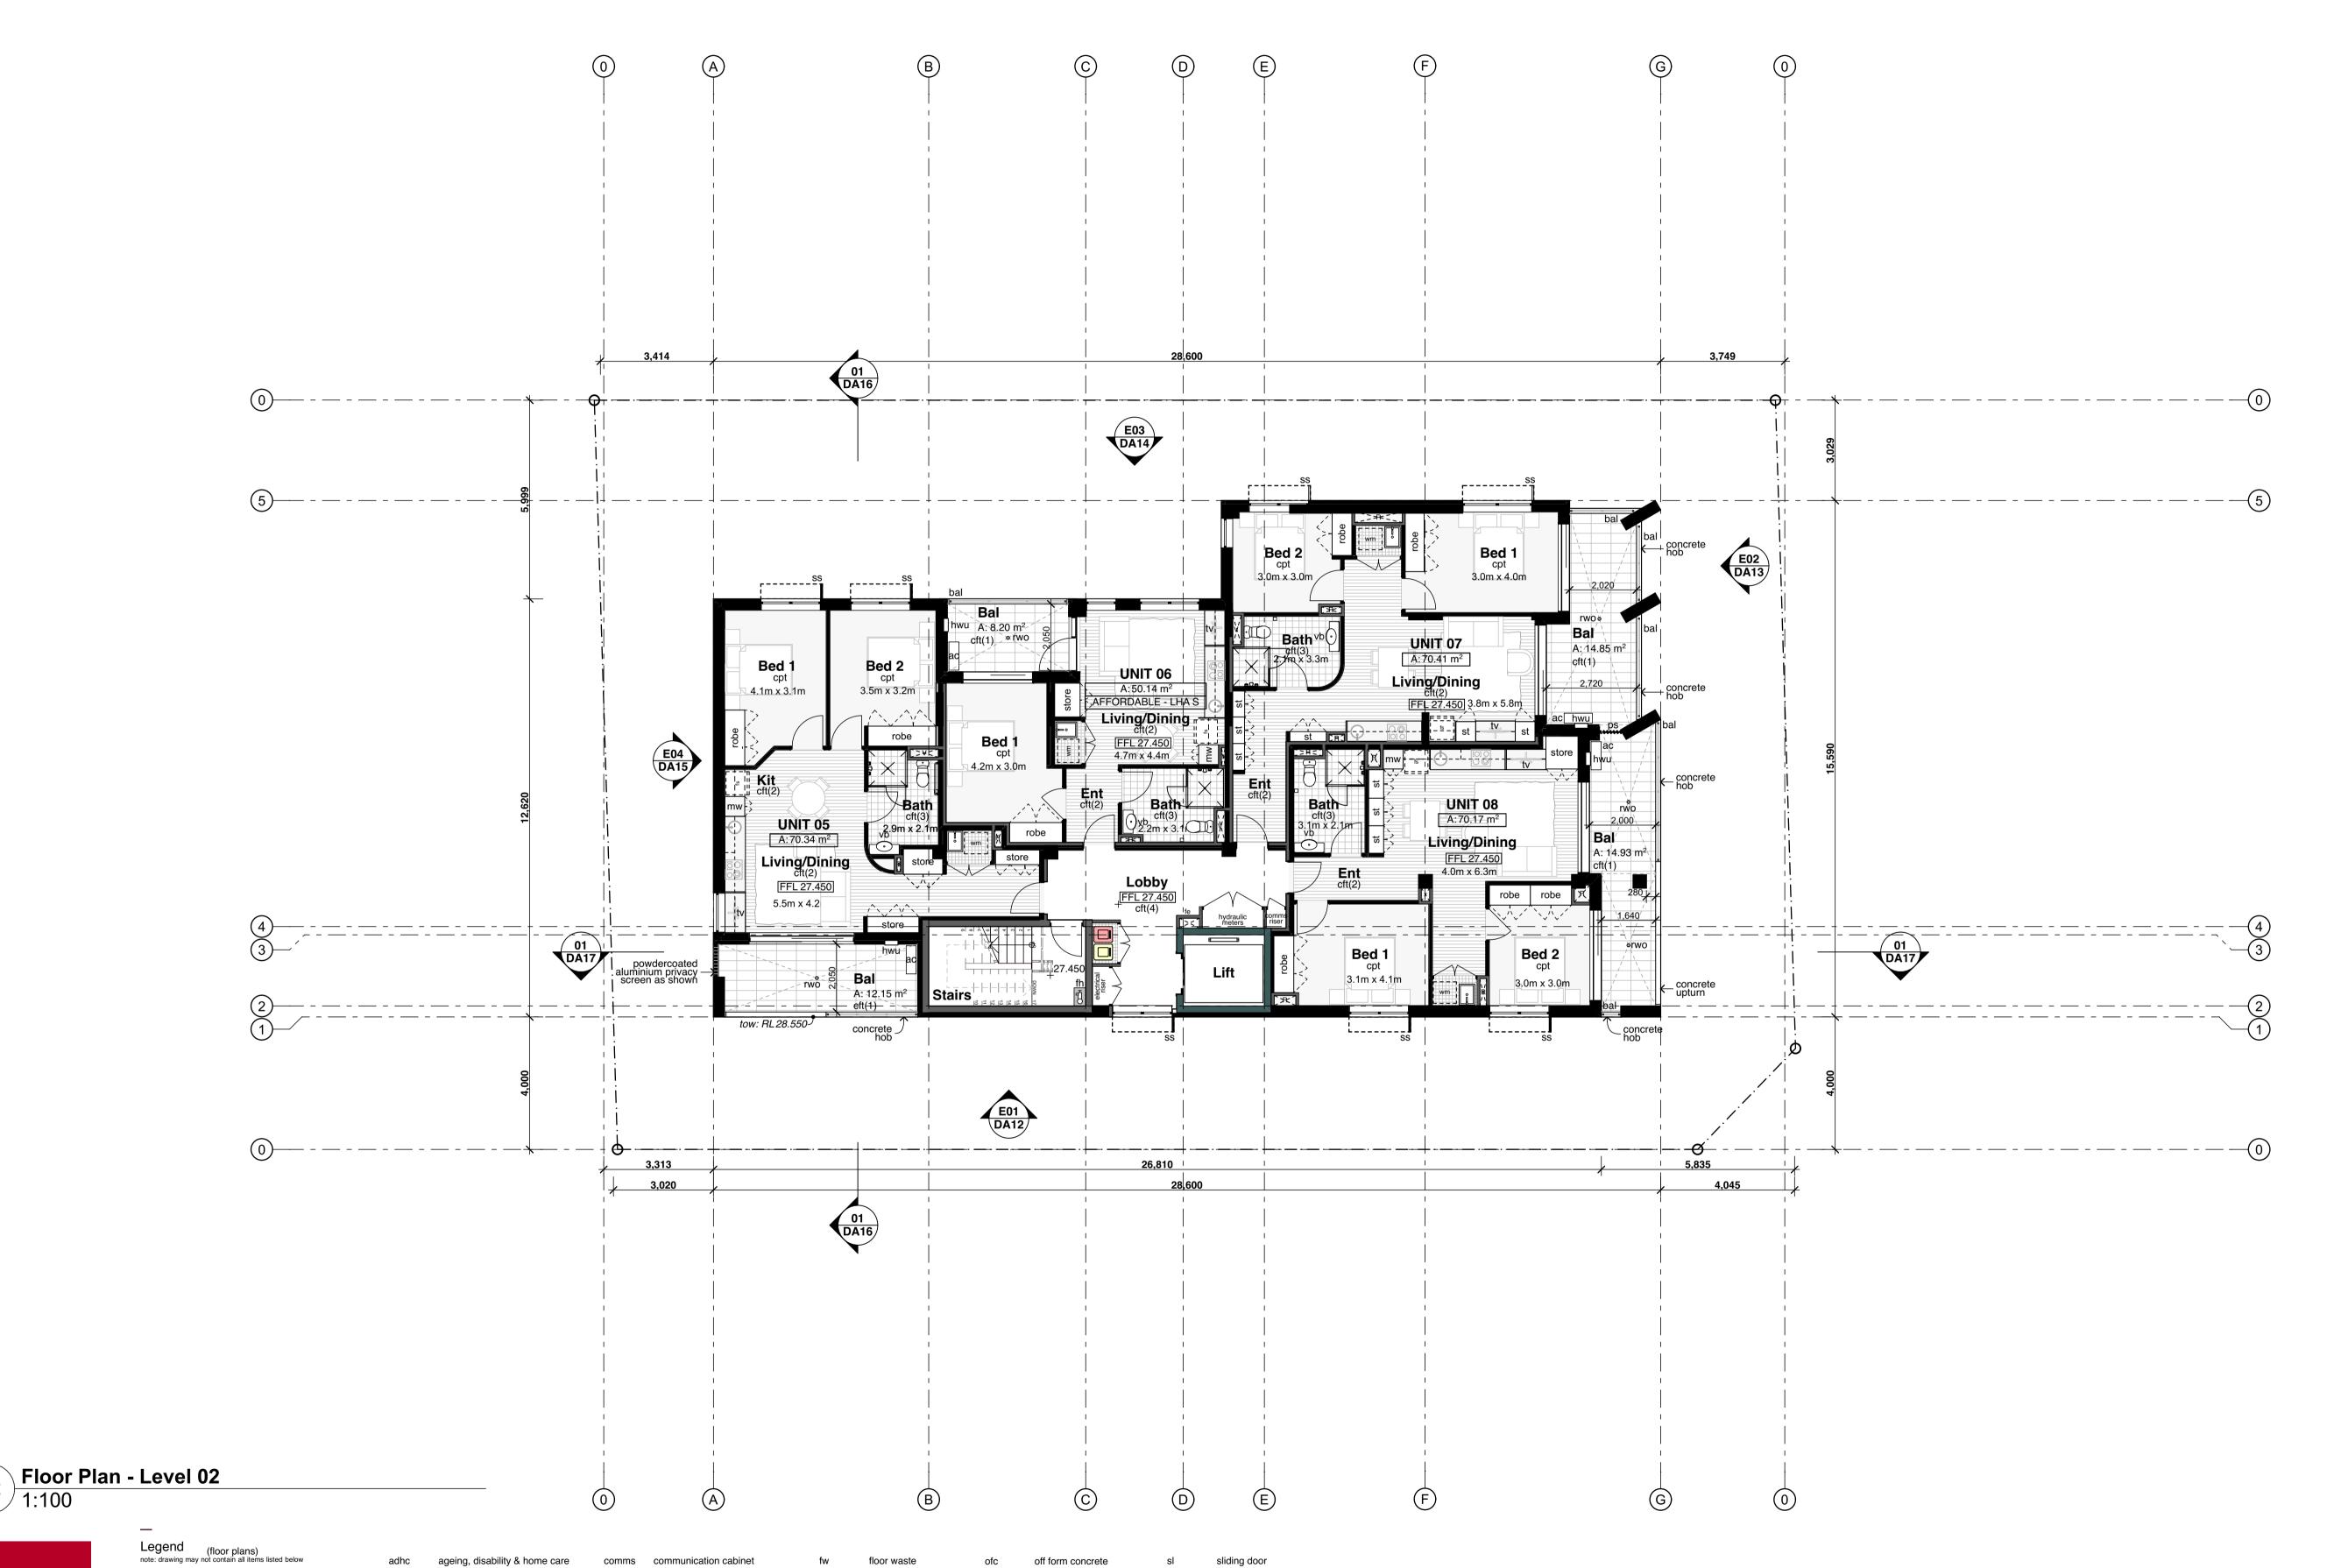
Project No; 2827.22

Drawing No; DA03

Floor Plan - Level 01

Revision#;

04



wood float concrete

washing machine space

tactile ground surface indicators

UNIT 06——•Unit number

A:50.00 m² Unit total area

*LHA S refers to Livable Housing Australia - Silver Level

AFFORDABLE - LHA S Unit type

storm water pit

vent pipe

wall oven

wheel stop

window casing

Legend

door numbers (as scheduled)

window numbers (as scheduled)

(prefix ex. for existing window)

wall type (as scheduled)

(prefix ex. for existing door)

ambulant

bal(1)

access panel

balustrade (type)

broom cupboard

control joint

clothes line

column

broom finish concrete

ceramic floor tile (type)

downpipe

doorpost

electrical distribution box

face brickwork (type)

fire hose reel

fridge space

floor mat

garbage bin

grated drain

hose tap

hydrant

kerb ramp

letter box

handrail (type)

hot water unit

linen cupboard

gate

hr(1)

permeable paving

retaining wall (type)

steel float concrete

privacy screen

wardrobe

steel column

skylight/skytube

shower

robe

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Hume Community Housing

Residential Apartments


23-25 Charles Street, Liverpool, NSW

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Scale;1:100 as noted @ AI

Project No; 2827.22

Drawing No; Revision#; DA04 04

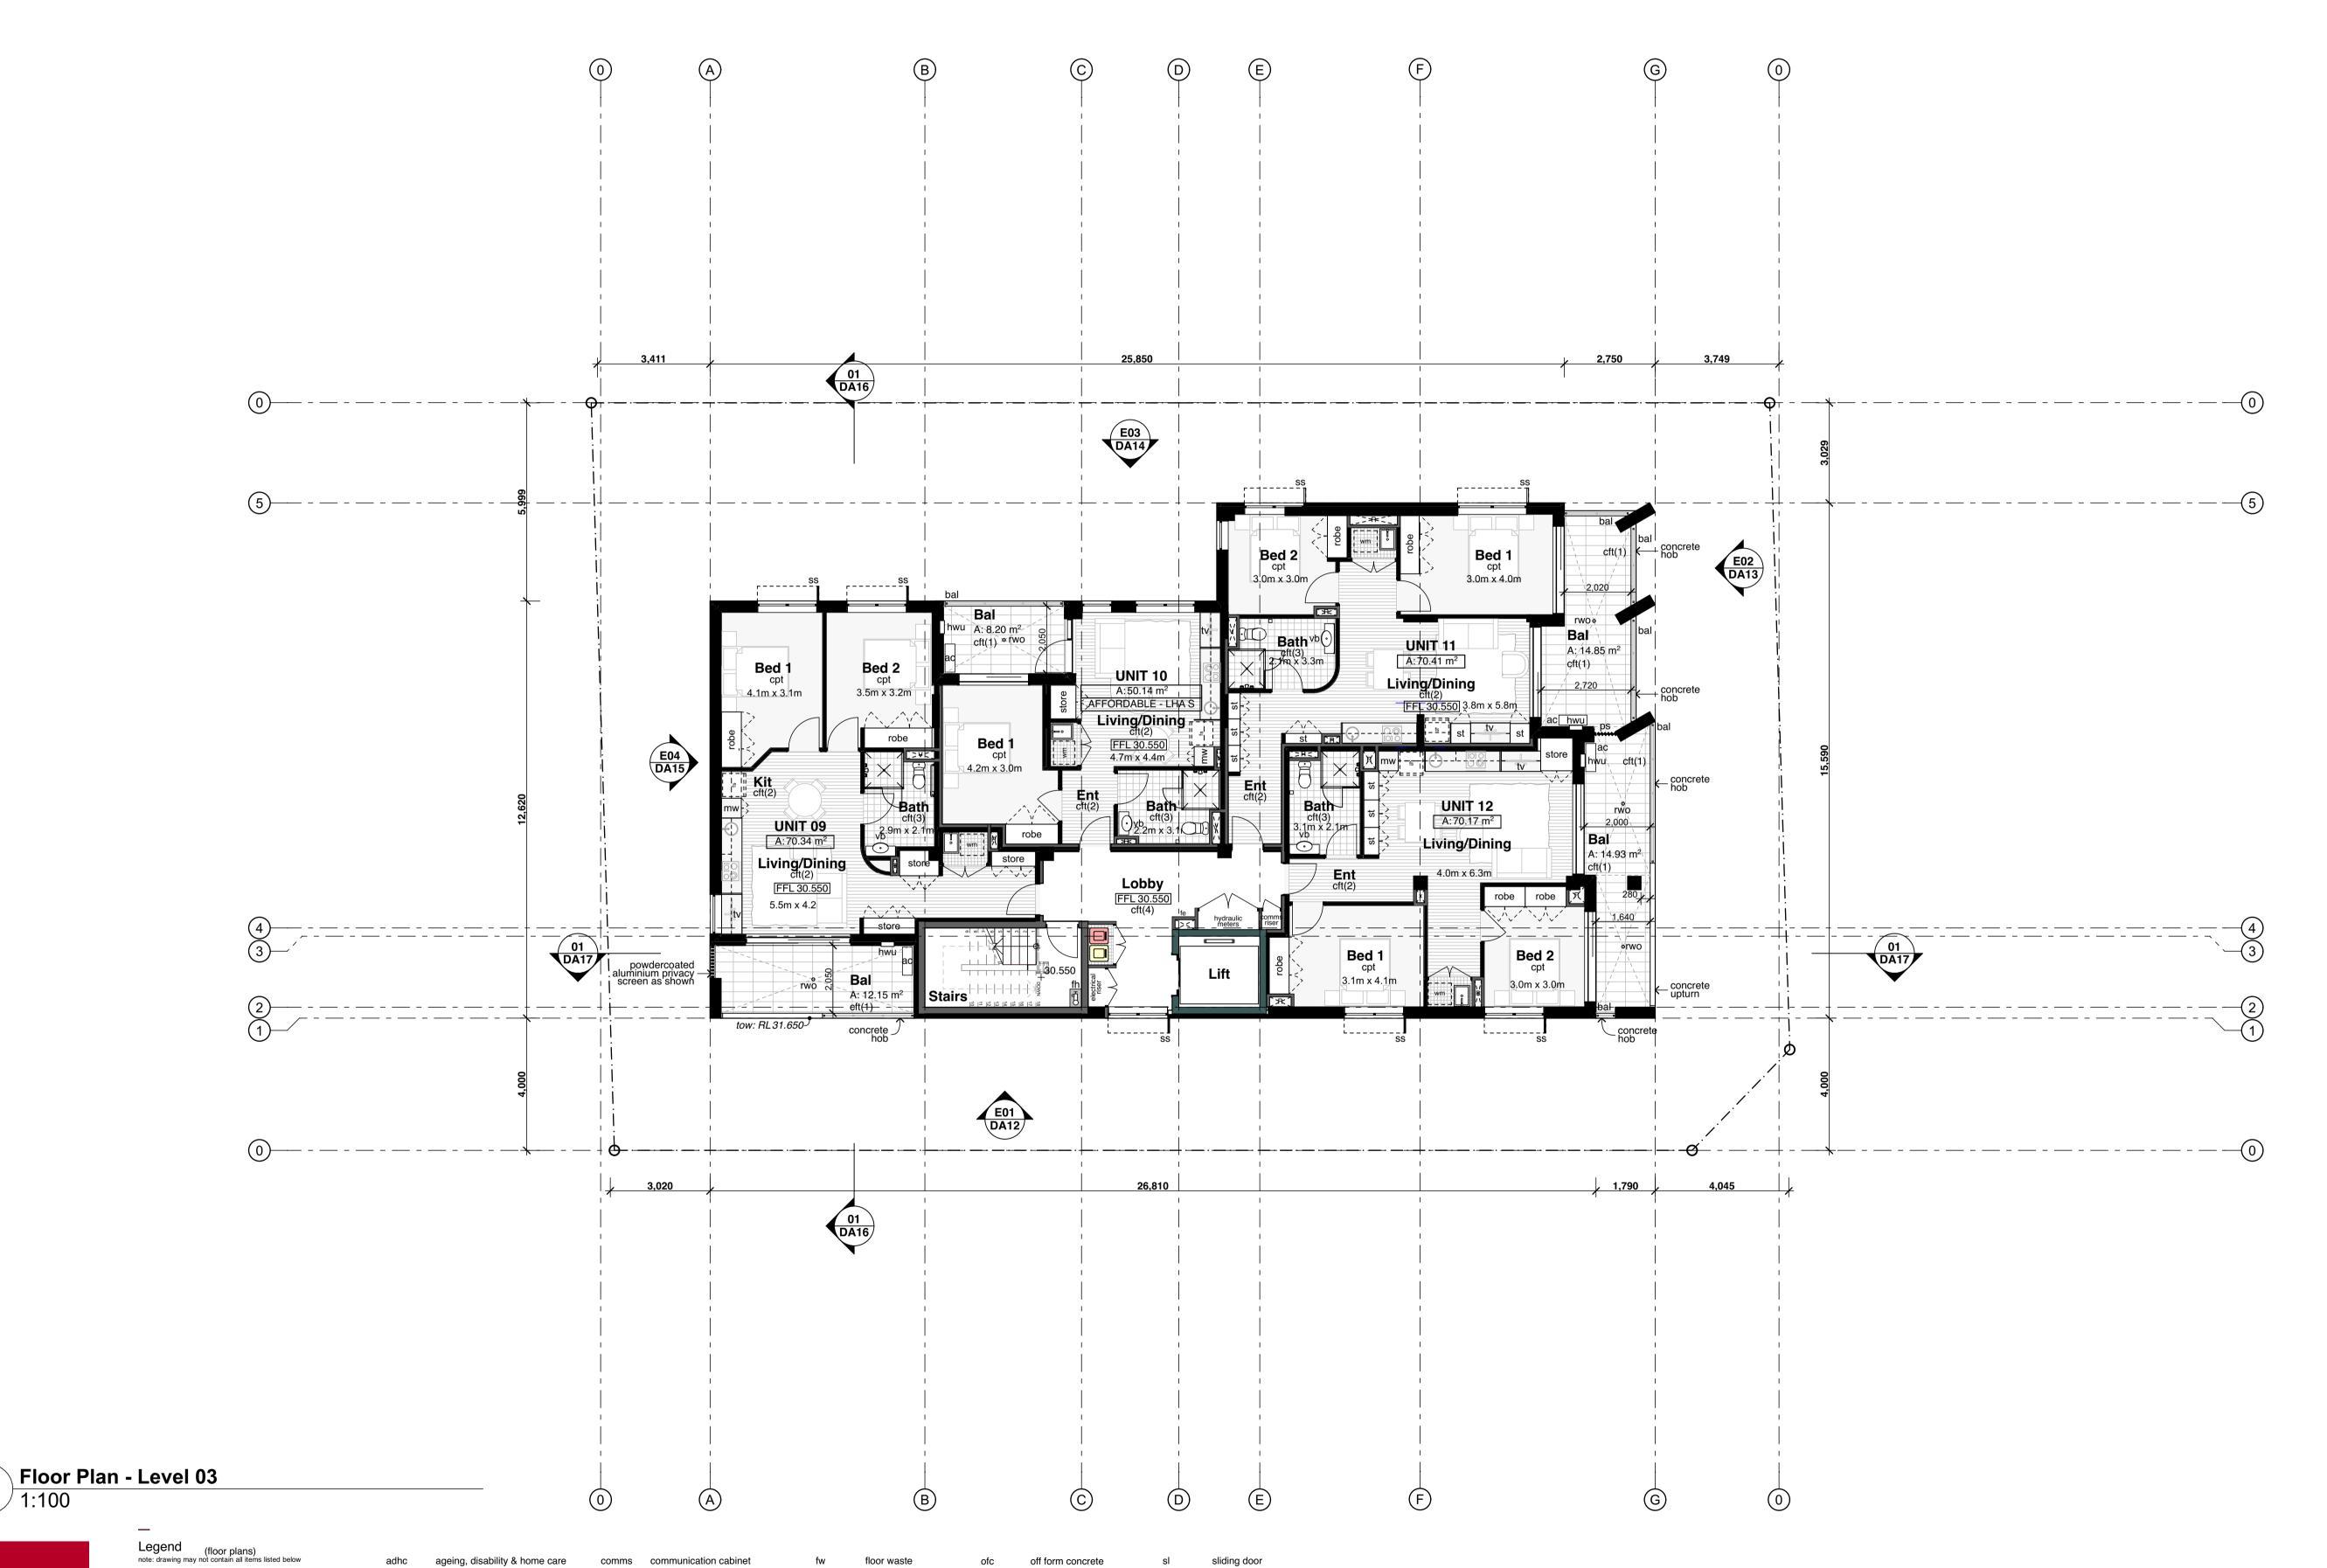

wood float concrete

washing machine space

tactile ground surface indicators

UNIT 06——•Unit number

A:50.00 m² Unit total area

*LHA S refers to Livable Housing Australia - Silver Level

AFFORDABLE - LHA S Unit type

storm water pit

vent pipe

wall oven

wheel stop

window casing

Legend

door numbers (as scheduled)

window numbers (as scheduled)

(prefix ex. for existing window)

wall type (as scheduled)

(prefix ex. for existing door)

ambulant

bal(1)

access panel

balustrade (type)

broom cupboard

control joint

clothes line

column

broom finish concrete

ceramic floor tile (type)

downpipe

doorpost

electrical distribution box

face brickwork (type)

fire hose reel

fridge space

feature panel

floor mat

garbage bin

grated drain

hose tap

hydrant

kerb ramp

letter box

handrail (type)

hot water unit

linen cupboard

gate

hr(1)

permeable paving

retaining wall (type)

steel float concrete

privacy screen

wardrobe

steel column

skylight/skytube

shower

robe

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04	Response to Council	

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Hume Community Housing

Residential Apartments

23-25 Charles Street, Liverpool, NSW

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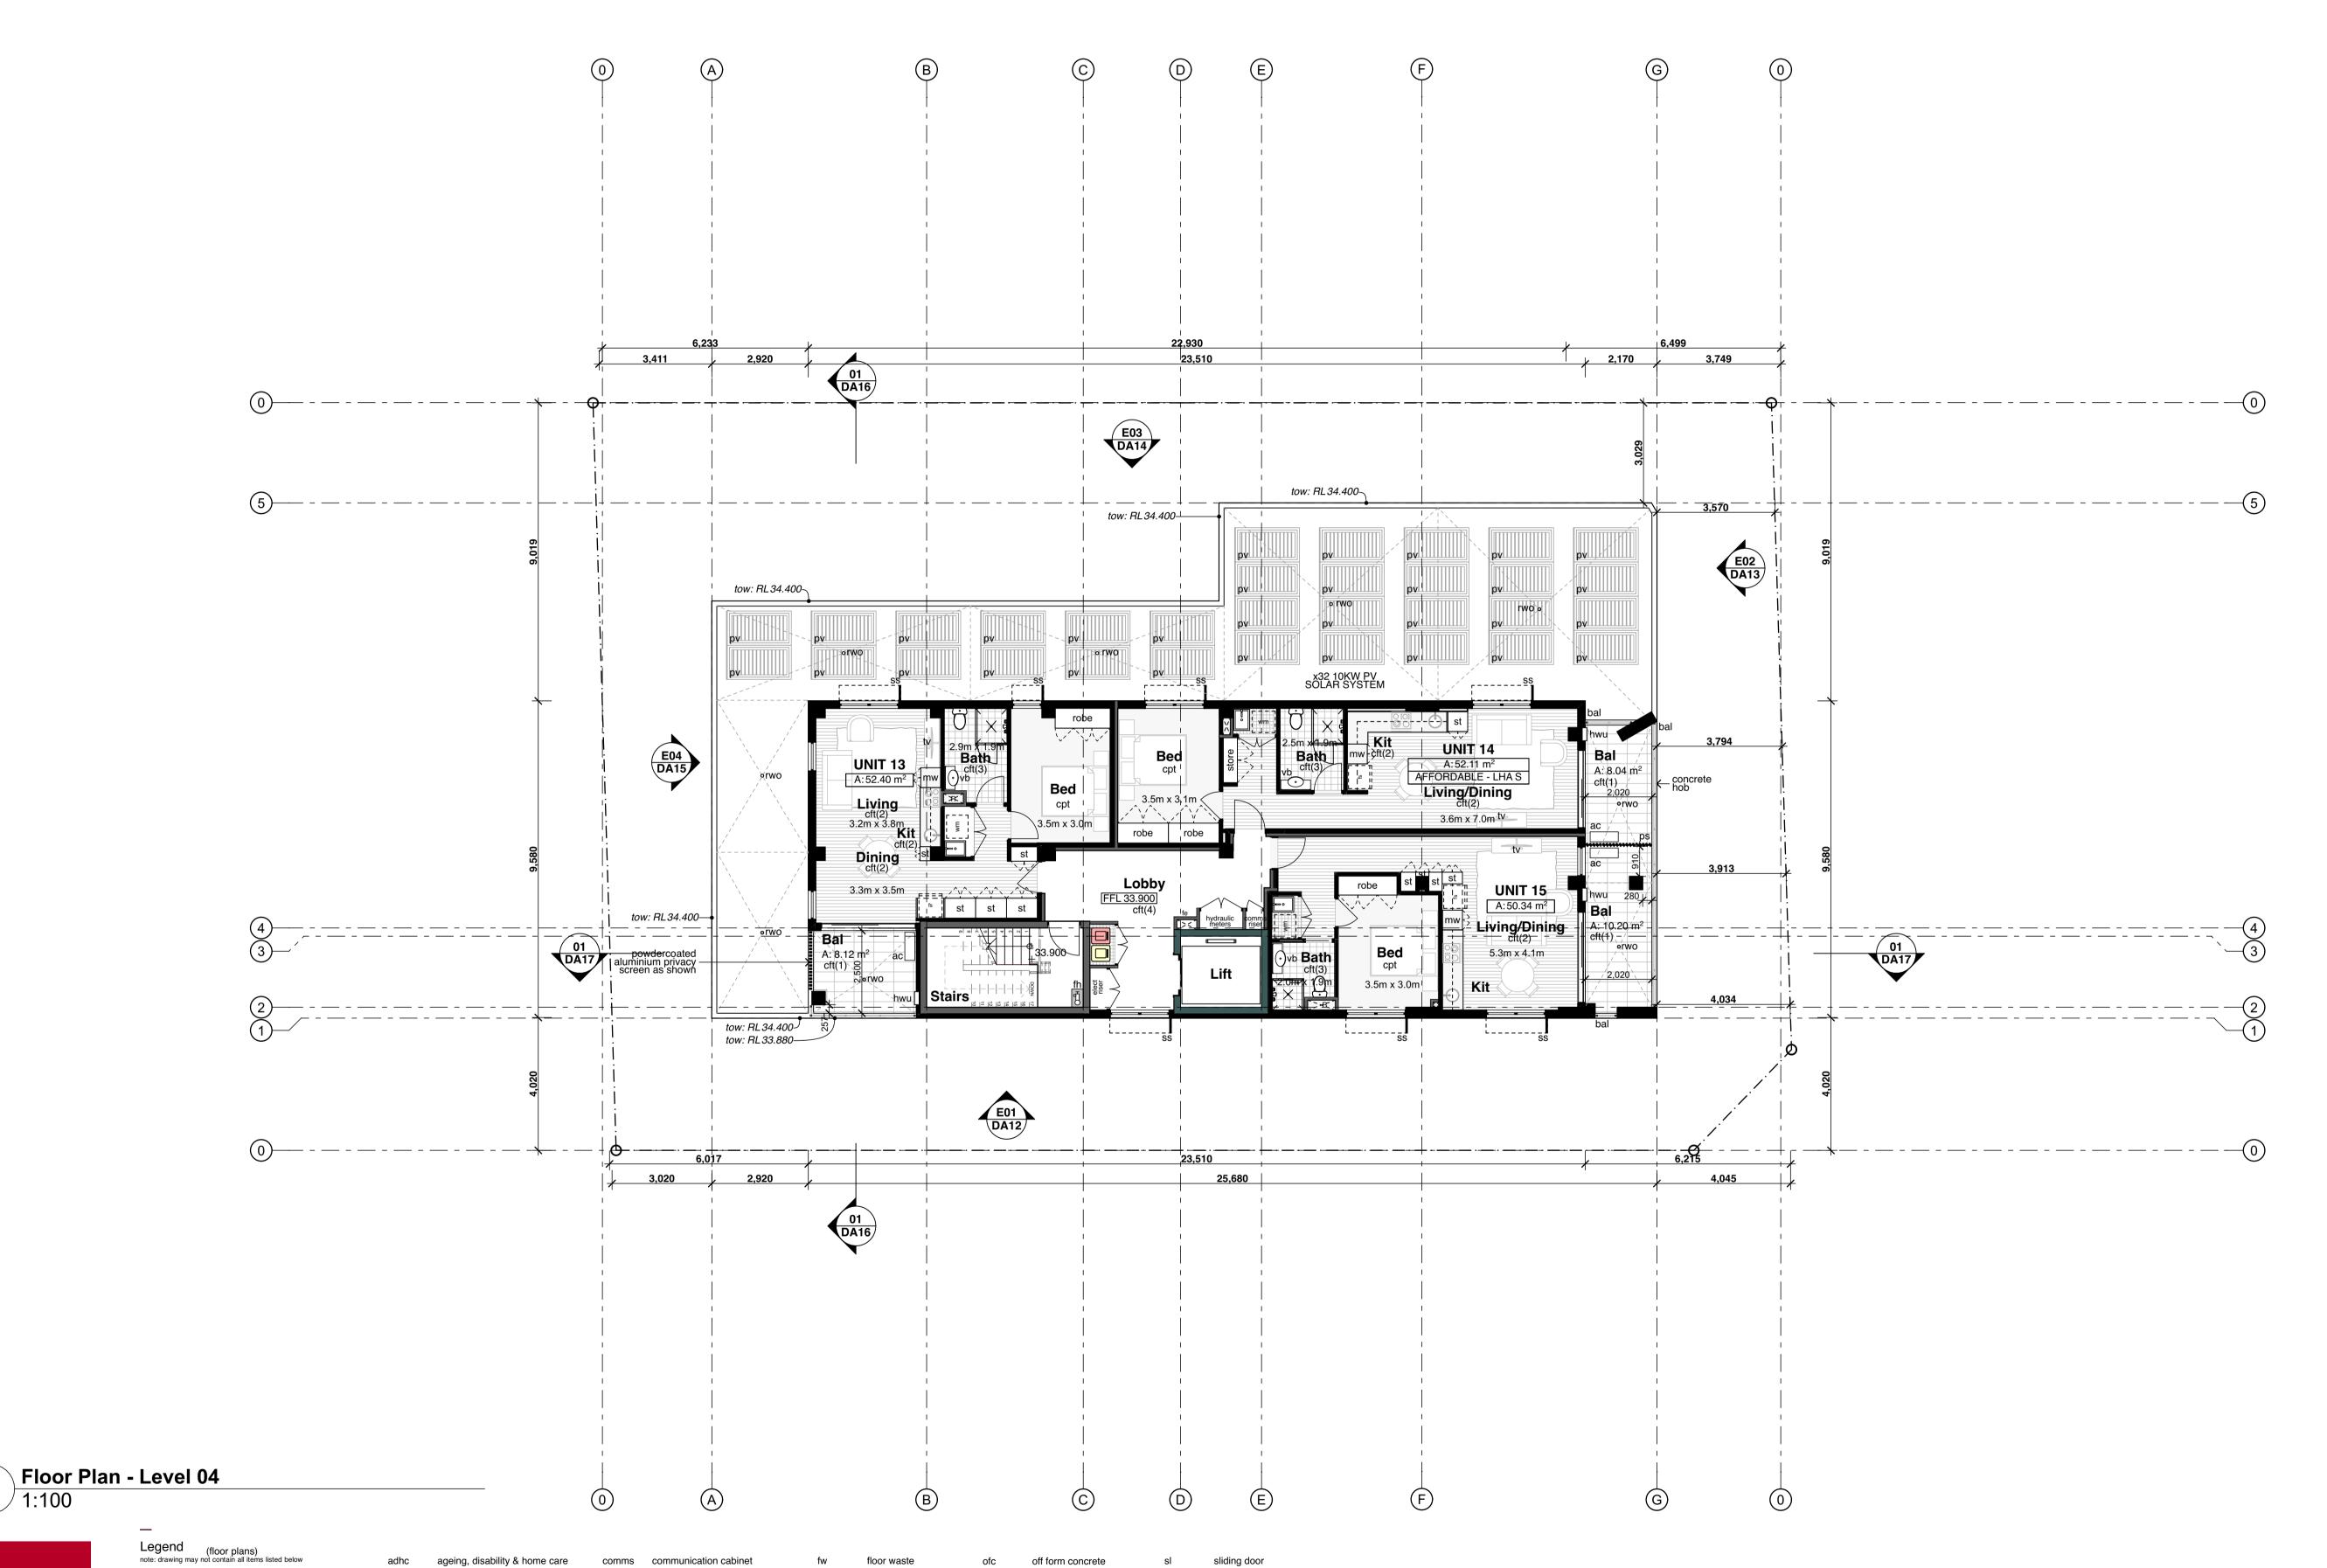
Project No; 2827.22

Drawing No; DA05

Floor Plan - Level 03

Revision#;

04



storm water pit

wood float concrete

washing machine space

vent pipe

wall oven

wheel stop

window casing

tactile ground surface indicators

UNIT 06——•Unit number

A:50.00 m² Unit total area

AFFORDABLE - LHA S

Unit type

*LHA S refers to Livable Housing Australia - Silver Level

Legend

door numbers (as scheduled)

window numbers (as scheduled)

(prefix ex. for existing window)

wall type (as scheduled)

(prefix ex. for existing door)

ambulant

bal(1)

access panel

balustrade (type)

broom cupboard

control joint

clothes line

column

broom finish concrete

ceramic floor tile (type)

downpipe

doorpost

electrical distribution box

face brickwork (type)

fire hose reel

fridge space

floor mat

garbage bin

grated drain

hose tap

hydrant

kerb ramp

letter box

linen cupboard

handrail (type)

hot water unit

gate

hr(1)

permeable paving

retaining wall (type)

steel float concrete

privacy screen

wardrobe

steel column

skylight/skytube

shower

robe

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Hume Community Housing

Residential Apartments

23-25 Charles Street, Liverpool, NSW

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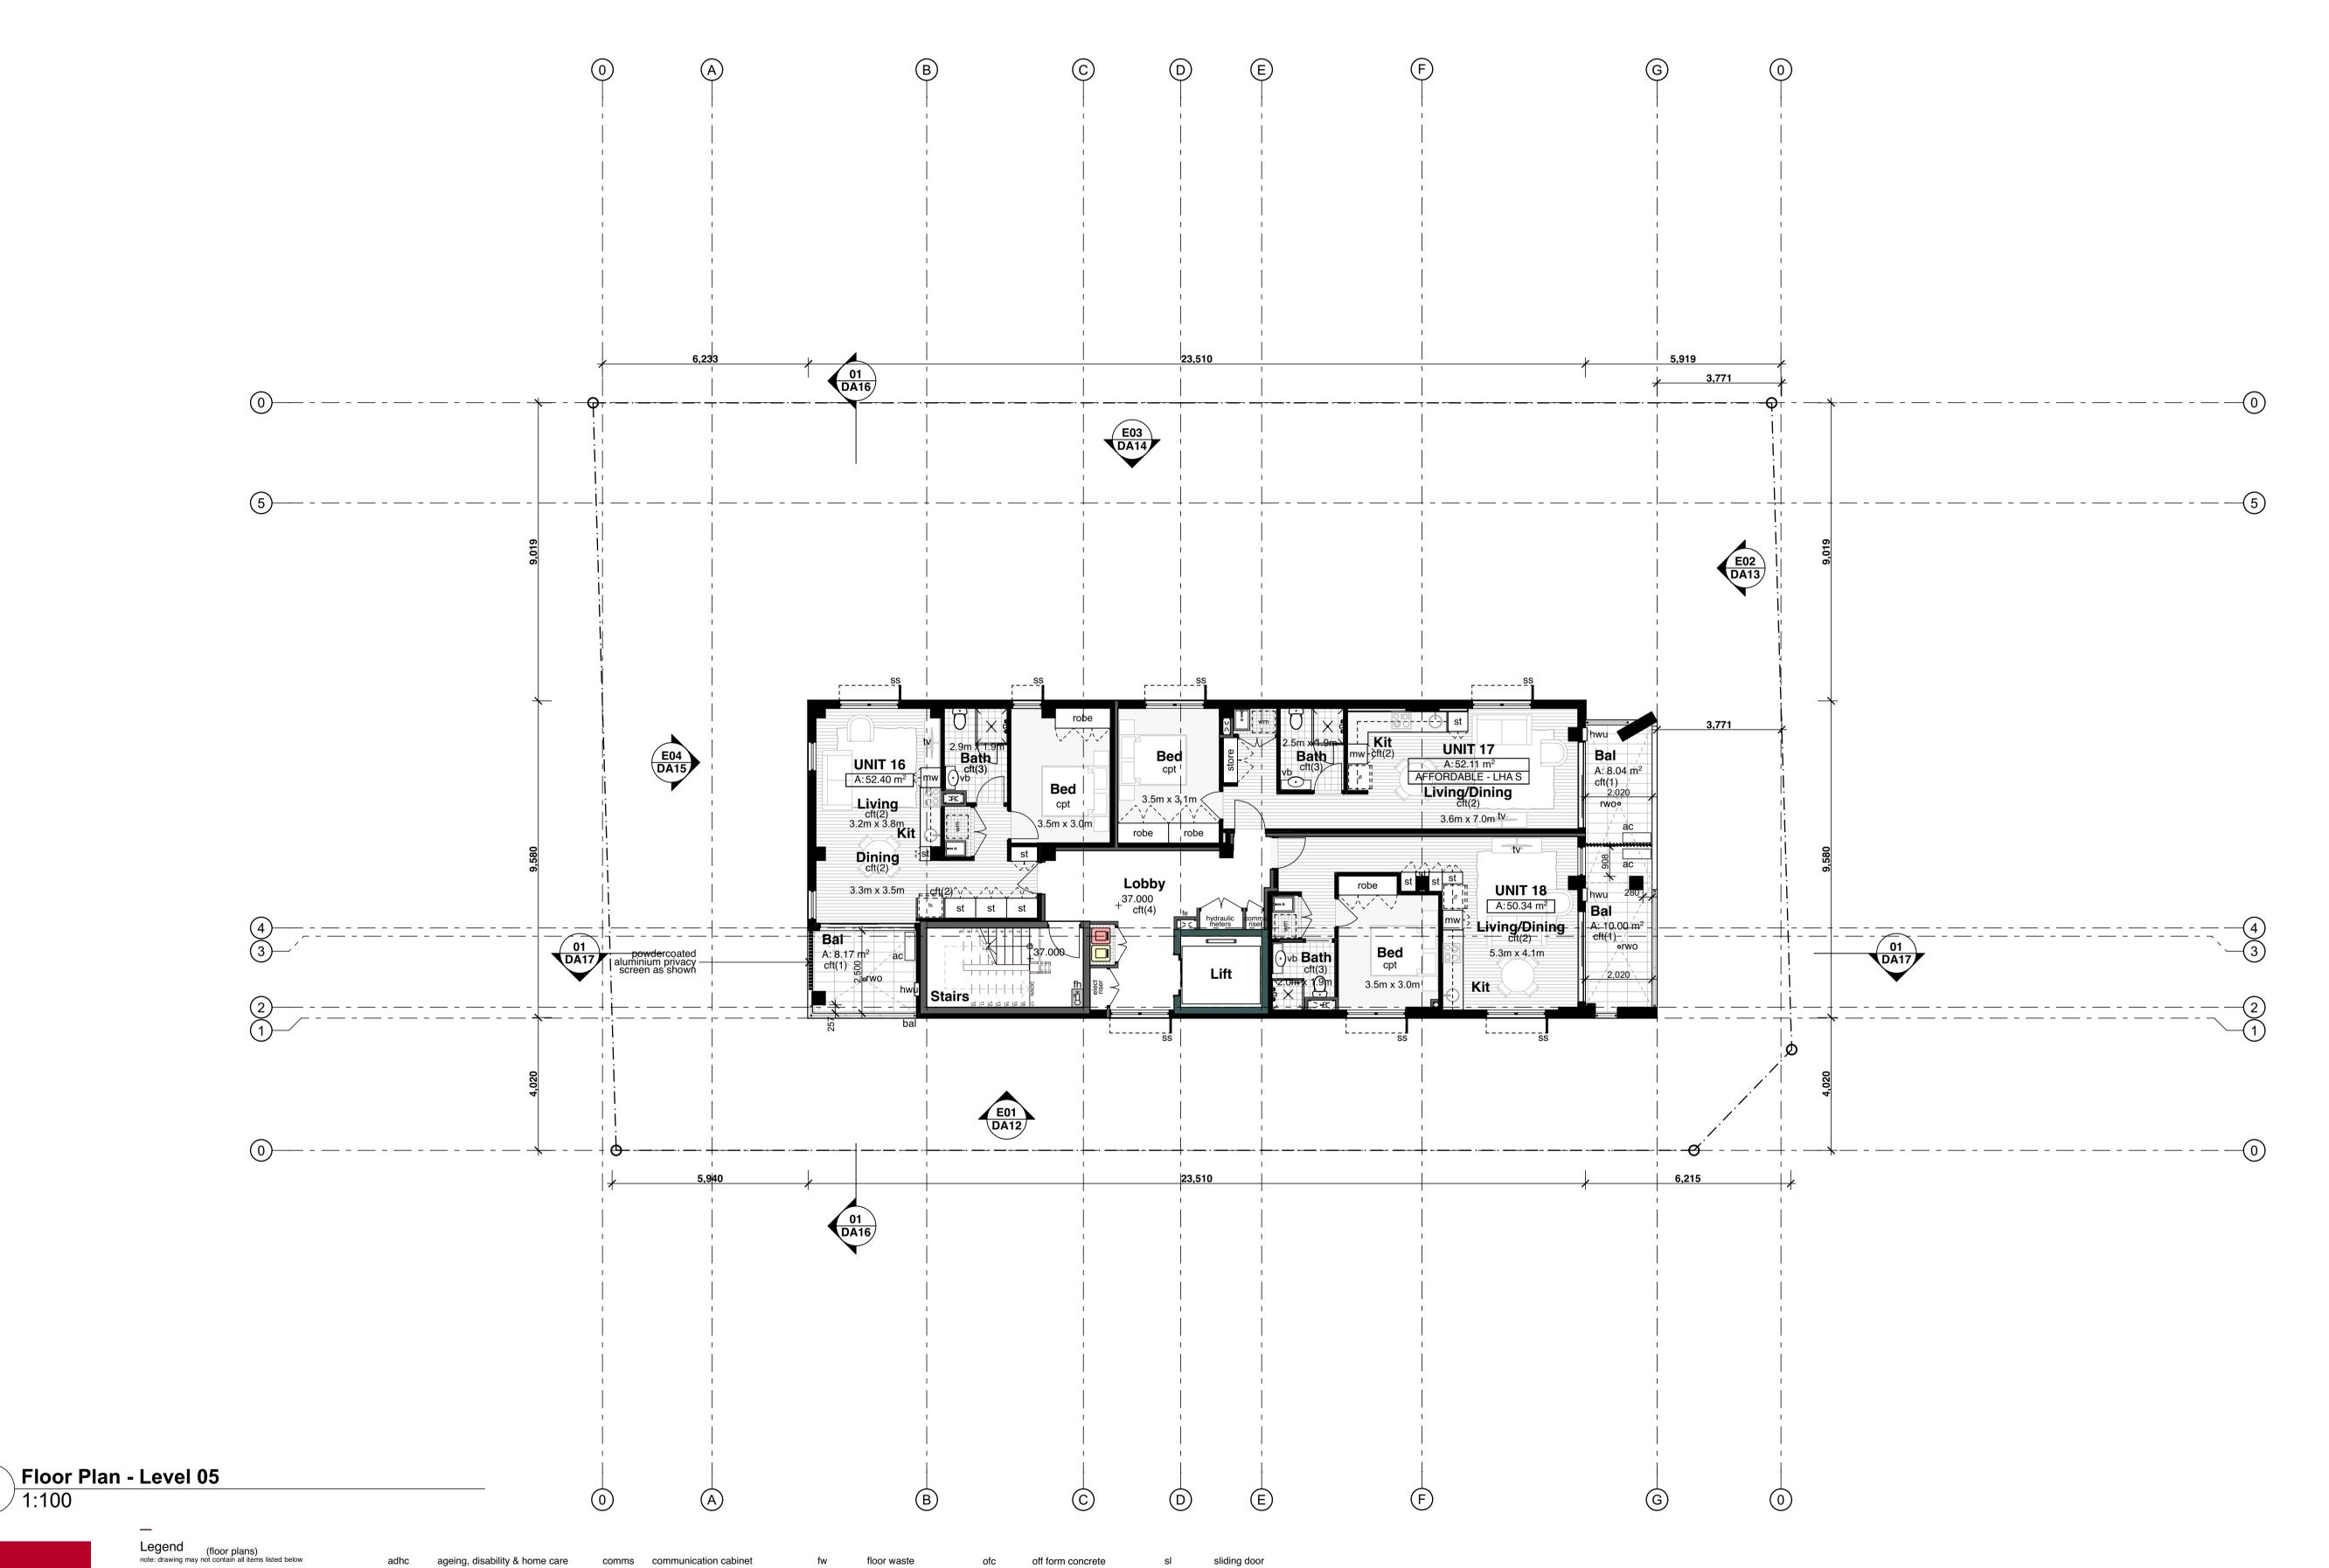
Project No; 2827.22

Drawing No; DA06

Floor Plan - Level 04

Revision#;

04



storm water pit

wood float concrete

washing machine space

vent pipe

wall oven

wheel stop

window casing

tactile ground surface indicators

UNIT 06——•Unit number

A:50.00 m² Unit total area

AFFORDABLE - LHA S

Unit type

*LHA S refers to Livable Housing Australia - Silver Level

ambulant

bal(1)

access panel

balustrade (type)

broom cupboard

control joint

clothes line

column

broom finish concrete

ceramic floor tile (type)

downpipe

doorpost

electrical distribution box

face brickwork (type)

fire hose reel

fridge space

floor mat

door numbers (as scheduled)

window numbers (as scheduled)

(prefix ex. for existing window)

wall type (as scheduled)

(prefix ex. for existing door)

garbage bin

grated drain

hose tap

hydrant

kerb ramp

letter box

linen cupboard

handrail (type)

hot water unit

gate

hr(1)

permeable paving

retaining wall (type)

steel float concrete

privacy screen

wardrobe

steel column

skylight/skytube

shower

robe

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Comments







Hume Community Housing

Residential Apartments


23-25 Charles Street, Liverpool, NSW

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Scale; 1:100 as noted @ AI

Project No; **2827.22**

Drawing No; Revision#; DA07 04

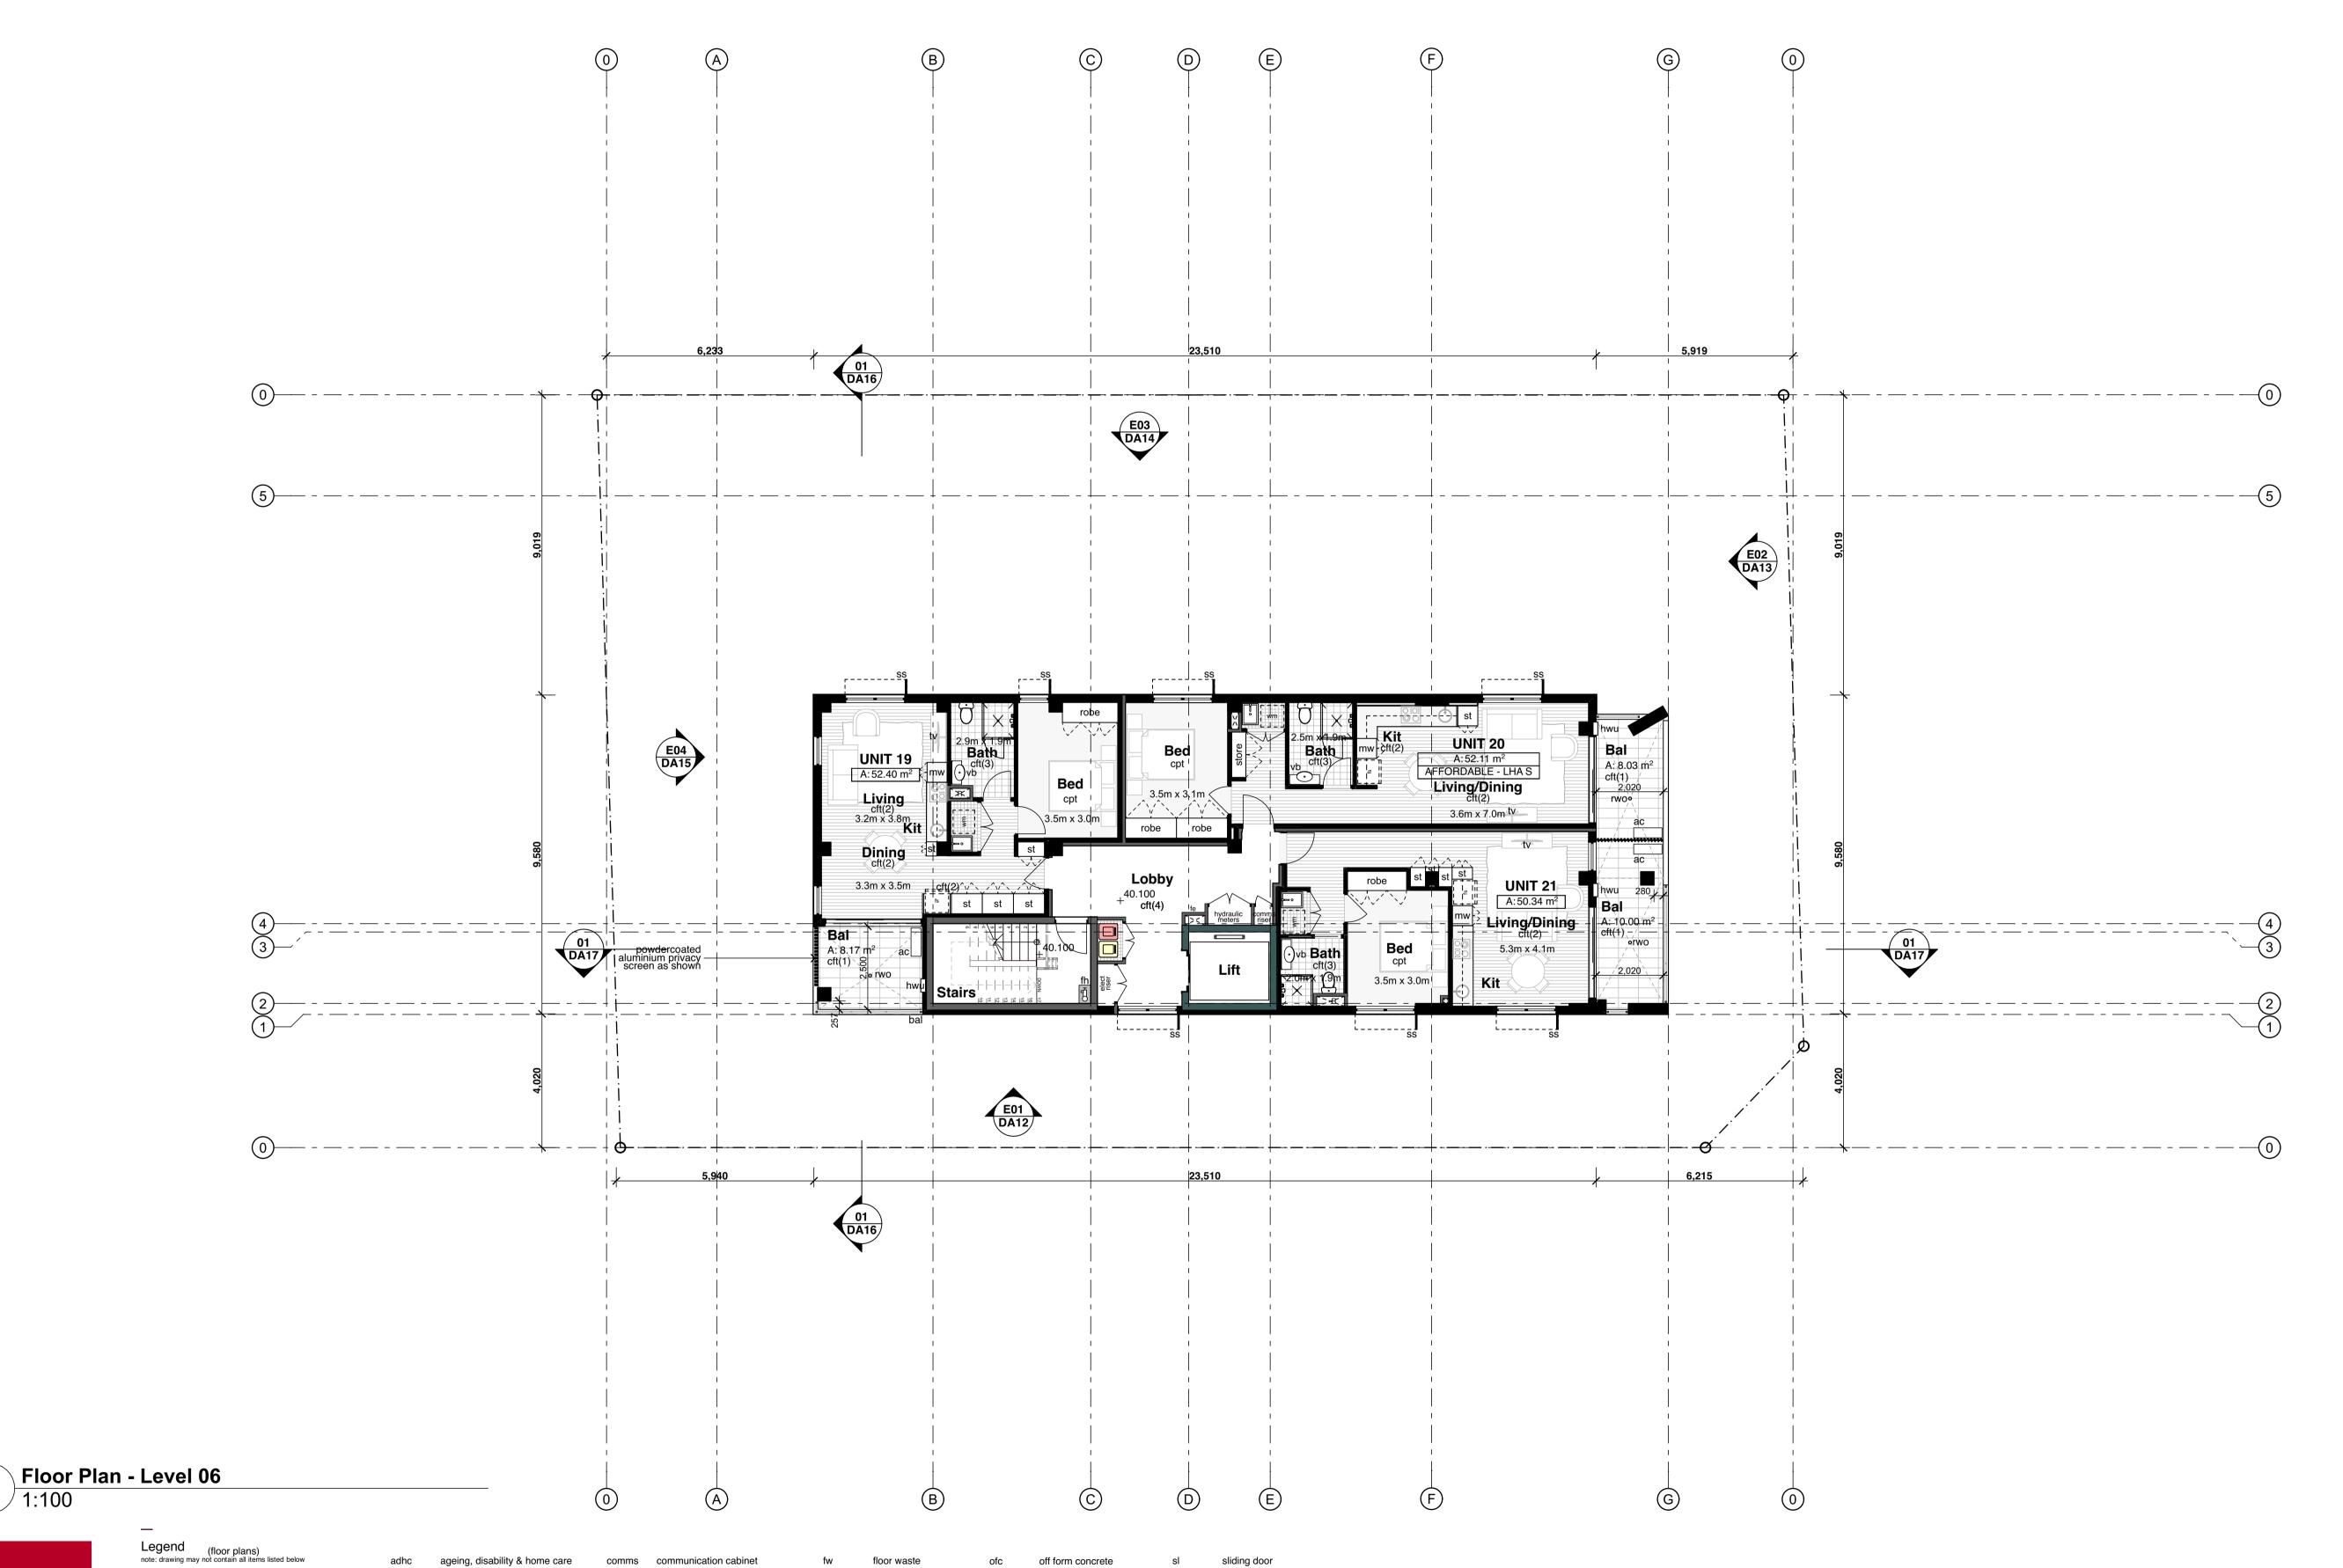

storm water pit

wood float concrete

washing machine space

vent pipe

wall oven

wheel stop

window casing

tactile ground surface indicators

UNIT 06——•Unit number

A:50.00 m² Unit total area

AFFORDABLE - LHA S

Unit type

*LHA S refers to Livable Housing Australia - Silver Level

ambulant

bal(1)

access panel

balustrade (type)

broom cupboard

control joint

clothes line

column

broom finish concrete

ceramic floor tile (type)

downpipe

doorpost

electrical distribution box

face brickwork (type)

fire hose reel

fridge space

floor mat

door numbers (as scheduled)

window numbers (as scheduled)

(prefix ex. for existing window)

wall type (as scheduled)

(prefix ex. for existing door)

garbage bin

grated drain

hose tap

hydrant

kerb ramp

letter box

linen cupboard

handrail (type)

hot water unit

gate

hr(1)

permeable paving

retaining wall (type)

steel float concrete

privacy screen

wardrobe

steel column

skylight/skytube

shower

robe

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Residential Apartments


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Project No; 2827.22

Drawing No; Revision#; DA08 04



storm water pit

wood float concrete

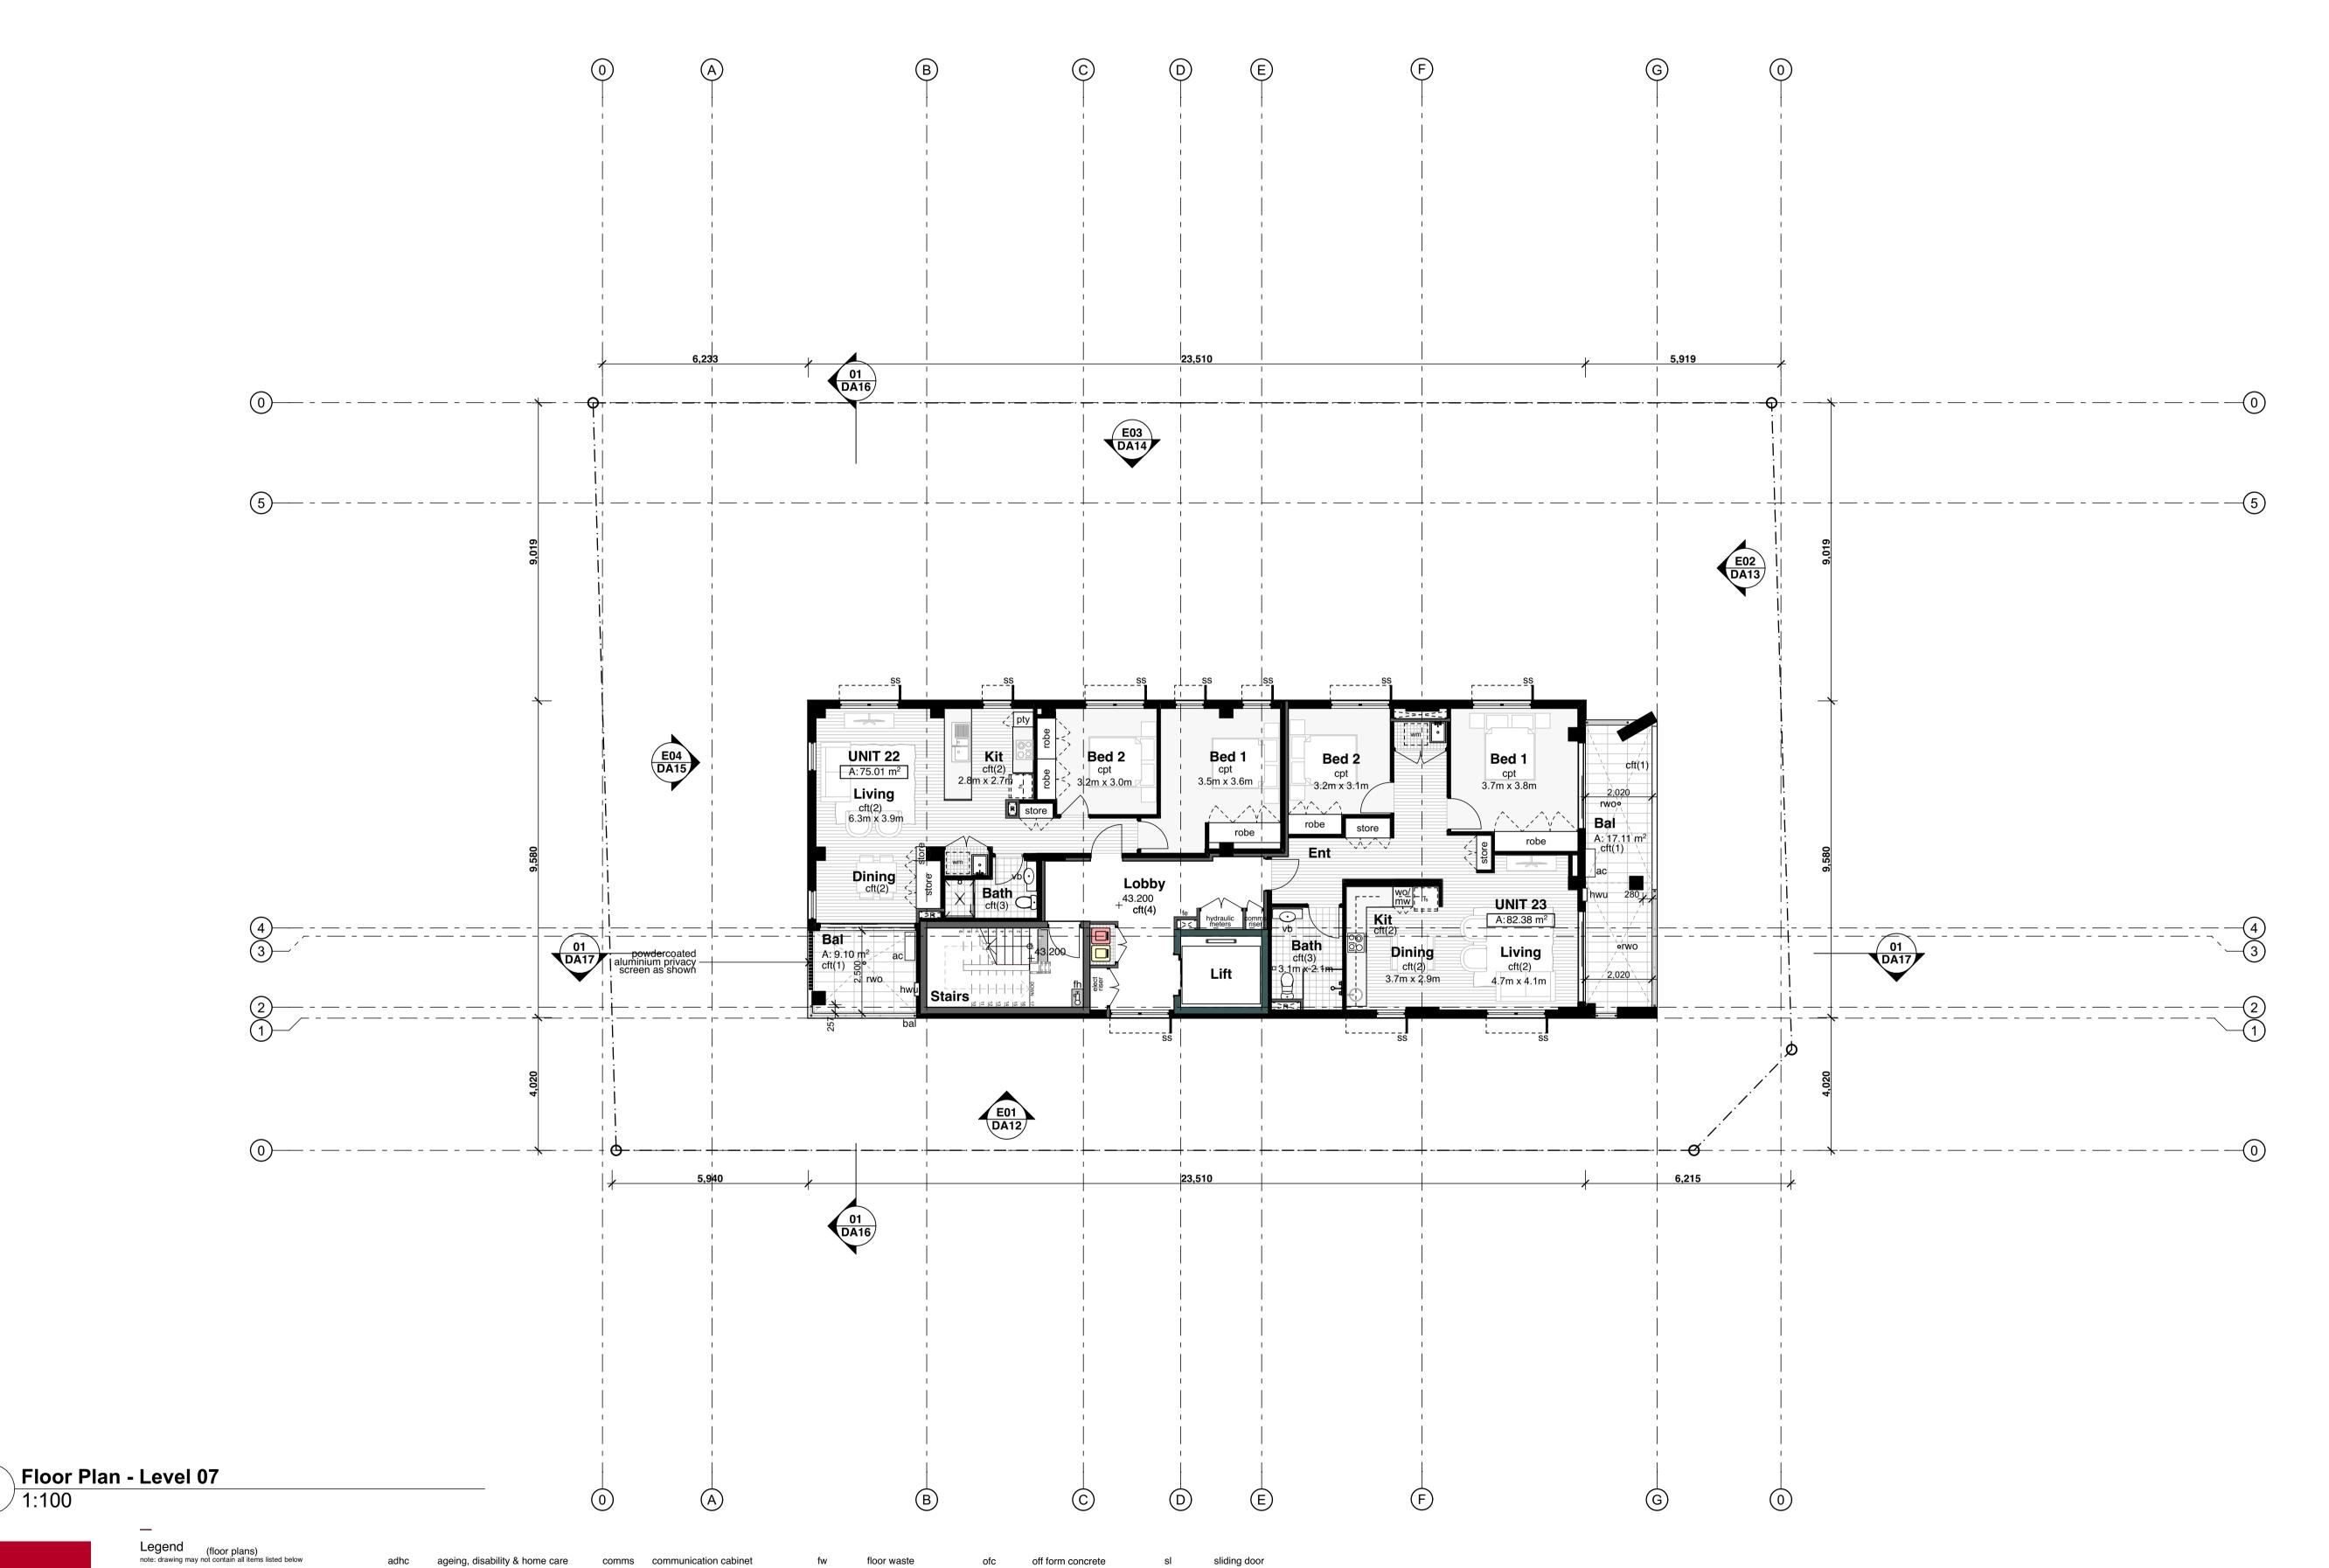washing machine space

vent pipe

wall oven

wheel stop

window casing

tactile ground surface indicators

UNIT 06——•Unit number

A:50.00 m² Unit total area

AFFORDABLE - LHA S

Unit type

*LHA S refers to Livable Housing Australia - Silver Level

ambulant

bal(1)

access panel

balustrade (type)

broom cupboard

control joint

clothes line

column

broom finish concrete

ceramic floor tile (type)

downpipe

doorpost

fire hose reel

fridge space

floor mat

electrical distribution box

face brickwork (type)

door numbers (as scheduled) (prefix ex. for existing door)

window numbers (as scheduled)

(prefix ex. for existing window)

wall type (as scheduled)

garbage bin

grated drain

hose tap

hydrant

kerb ramp

letter box

linen cupboard

handrail (type)

hot water unit

gate

hr(1)

permeable paving

retaining wall (type)

steel float concrete

privacy screen

wardrobe

steel column

skylight/skytube

shower

robe

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03	S4.55 Submission in Response to Panel Meeting	28/06/23
04	S4.55 Submission in Response to Council	

Comments







Hume Community Housing

Residential Apartments


23-25 Charles Street, Liverpool, NSW

Drawn; jok Checked; jok Plot date; 1/9/2023

Scale;1:100 as noted @ AI

Project No; **2827.22**

Drawing No; Revision#; DA09 04

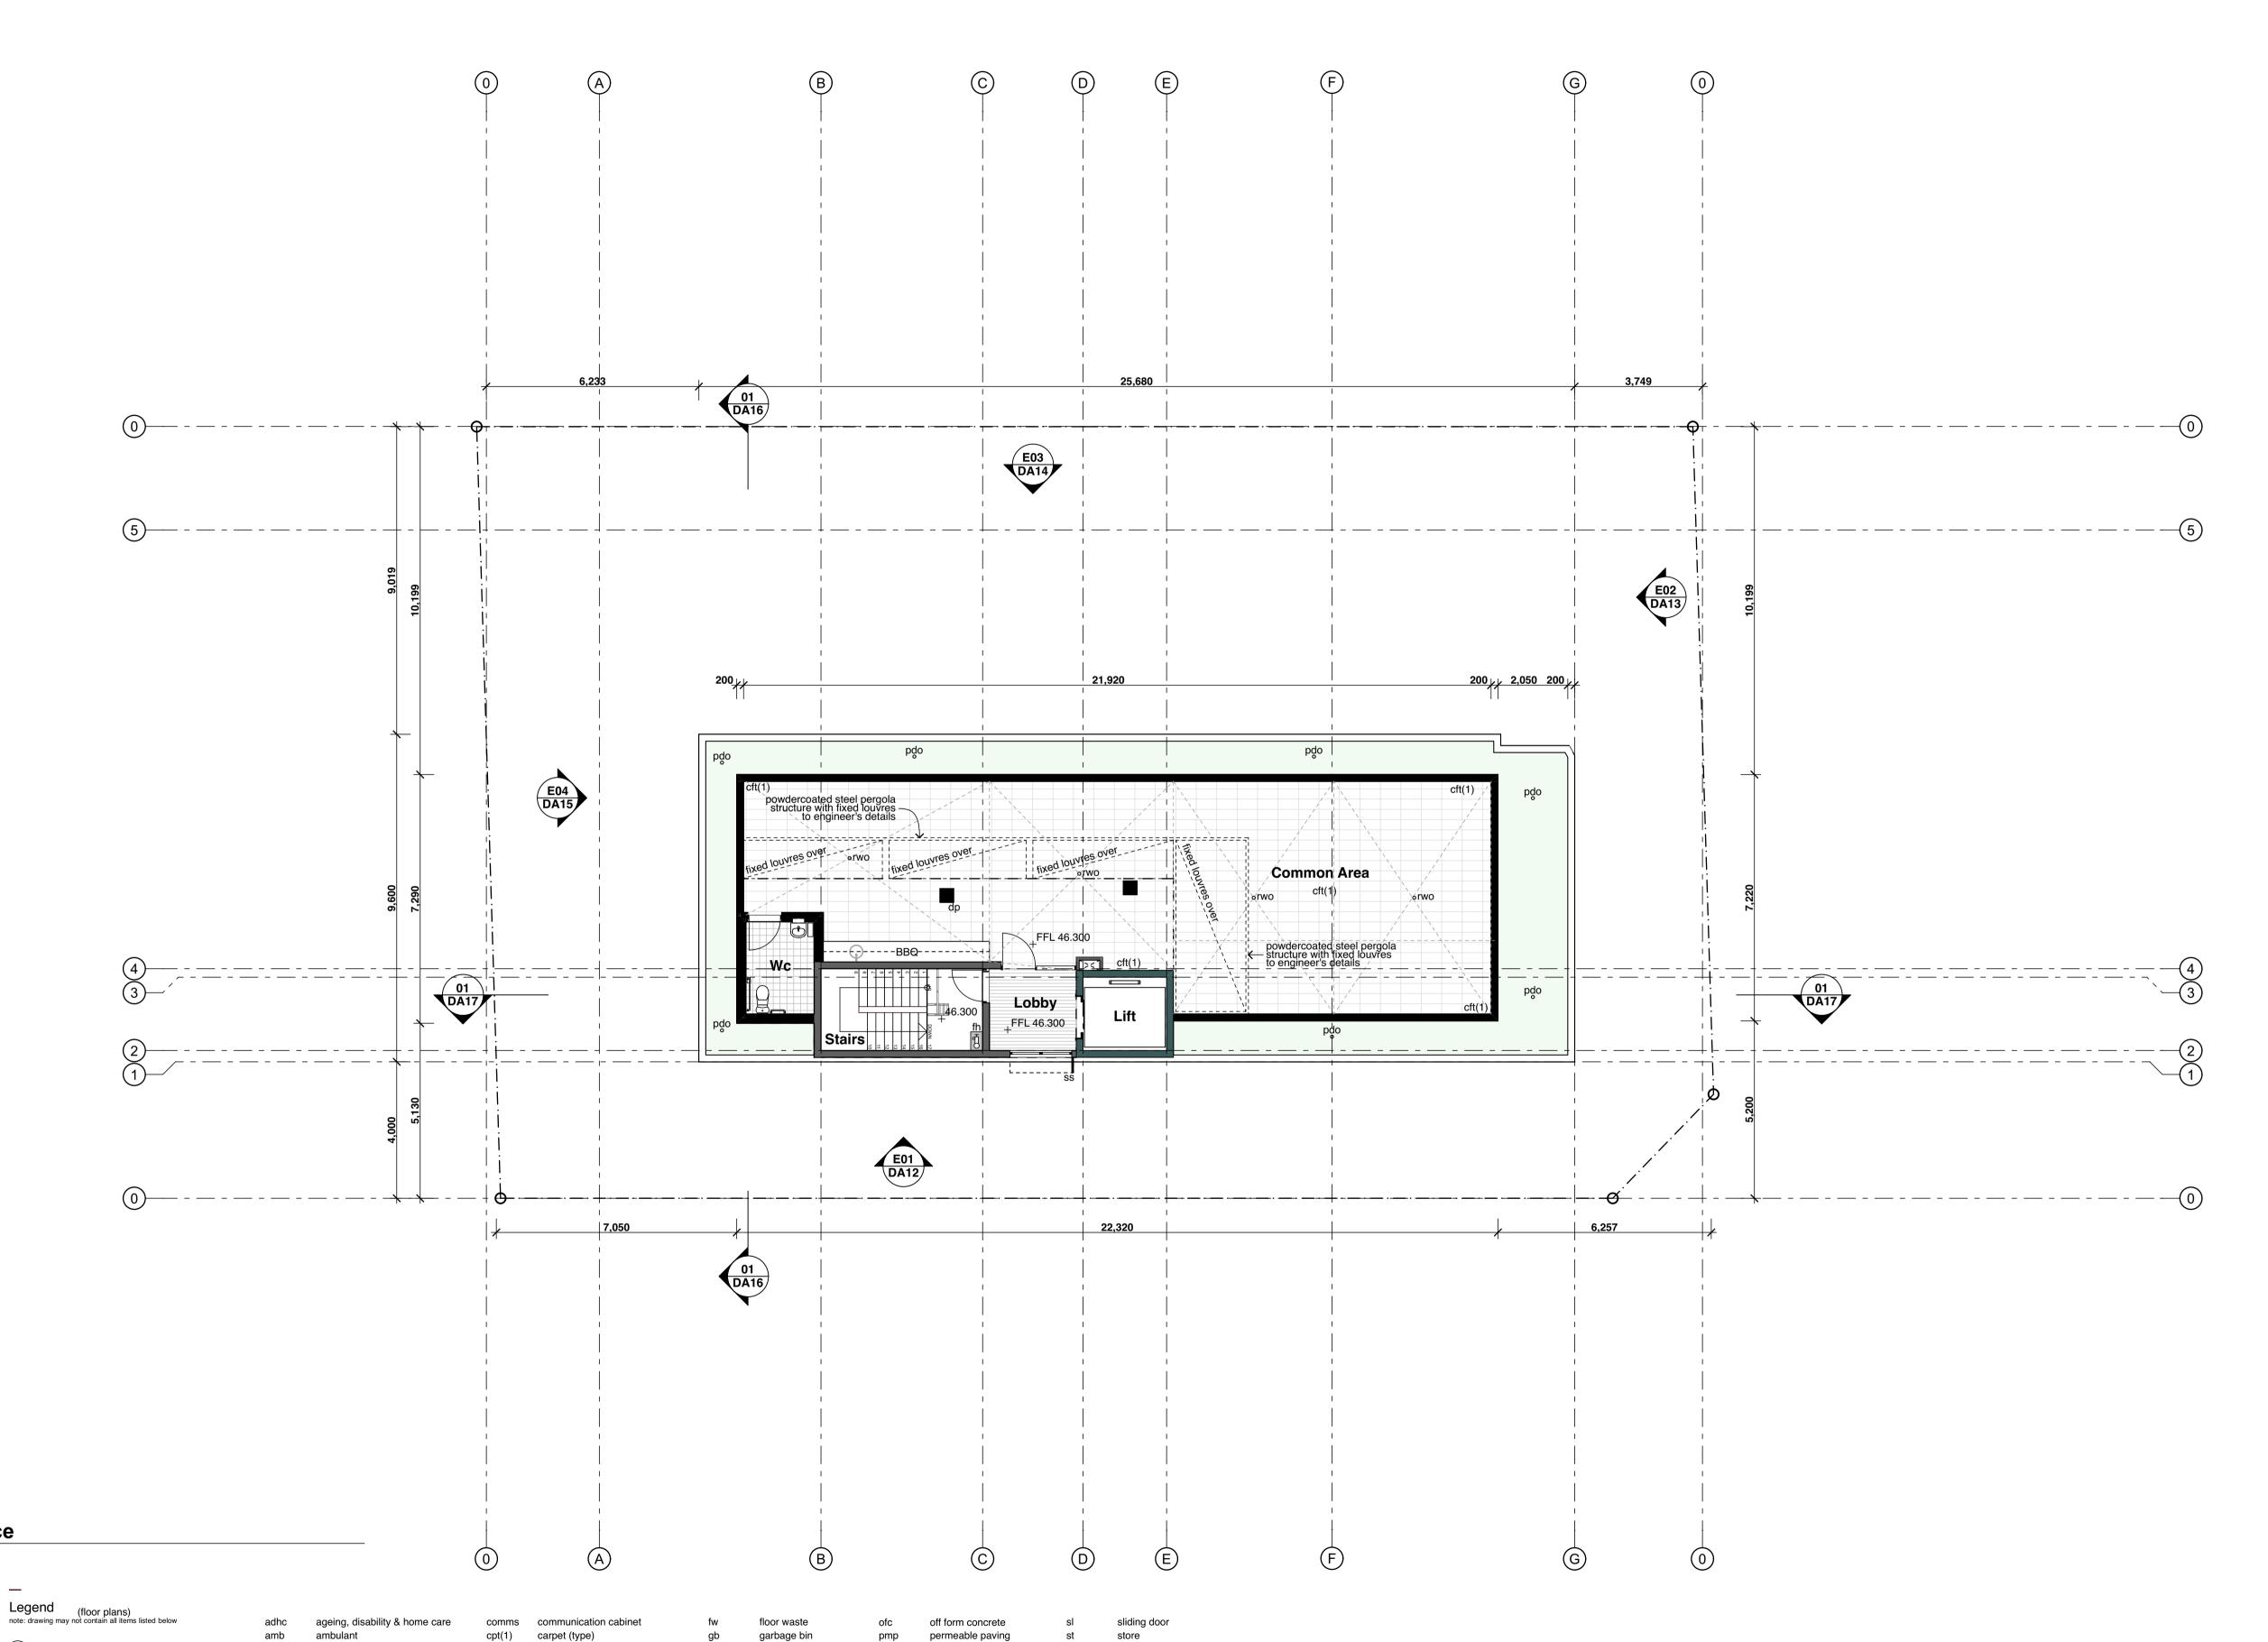

storm water pit

wood float concrete

washing machine space

vent pipe

wall oven

wheel stop

window casing

tactile ground surface indicators

UNIT 06——•Unit number

A:50.00 m² Unit total area

AFFORDABLE - LHA S

Unit type

*LHA S refers to Livable Housing Australia - Silver Level

privacy screen

retaining wall (type)

steel float concrete

wardrobe

steel column

skylight/skytube

shower

robe

gate

hr(1)

grated drain

hose tap

hydrant

kerb ramp

letter box

linen cupboard

handrail (type)

hot water unit

O1 Roof Terrace 1:100

door numbers (as scheduled) (prefix ex. for existing door)

window numbers (as scheduled)

(prefix ex. for existing window)

wall type (as scheduled)

access panel

balustrade (type)

broom cupboard

control joint

clothes line

column

broom finish concrete

ceramic floor tile (type)

downpipe

doorpost

fire hose reel

fridge space

floor mat

electrical distribution box

face brickwork (type)

bal(1)

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Hume Community Housing

Residential Apartments

23-25 Charles Street, Liverpool, NSW


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Drawing No; Revision#; DA 10 04

Floor Plan - Roof Terrace





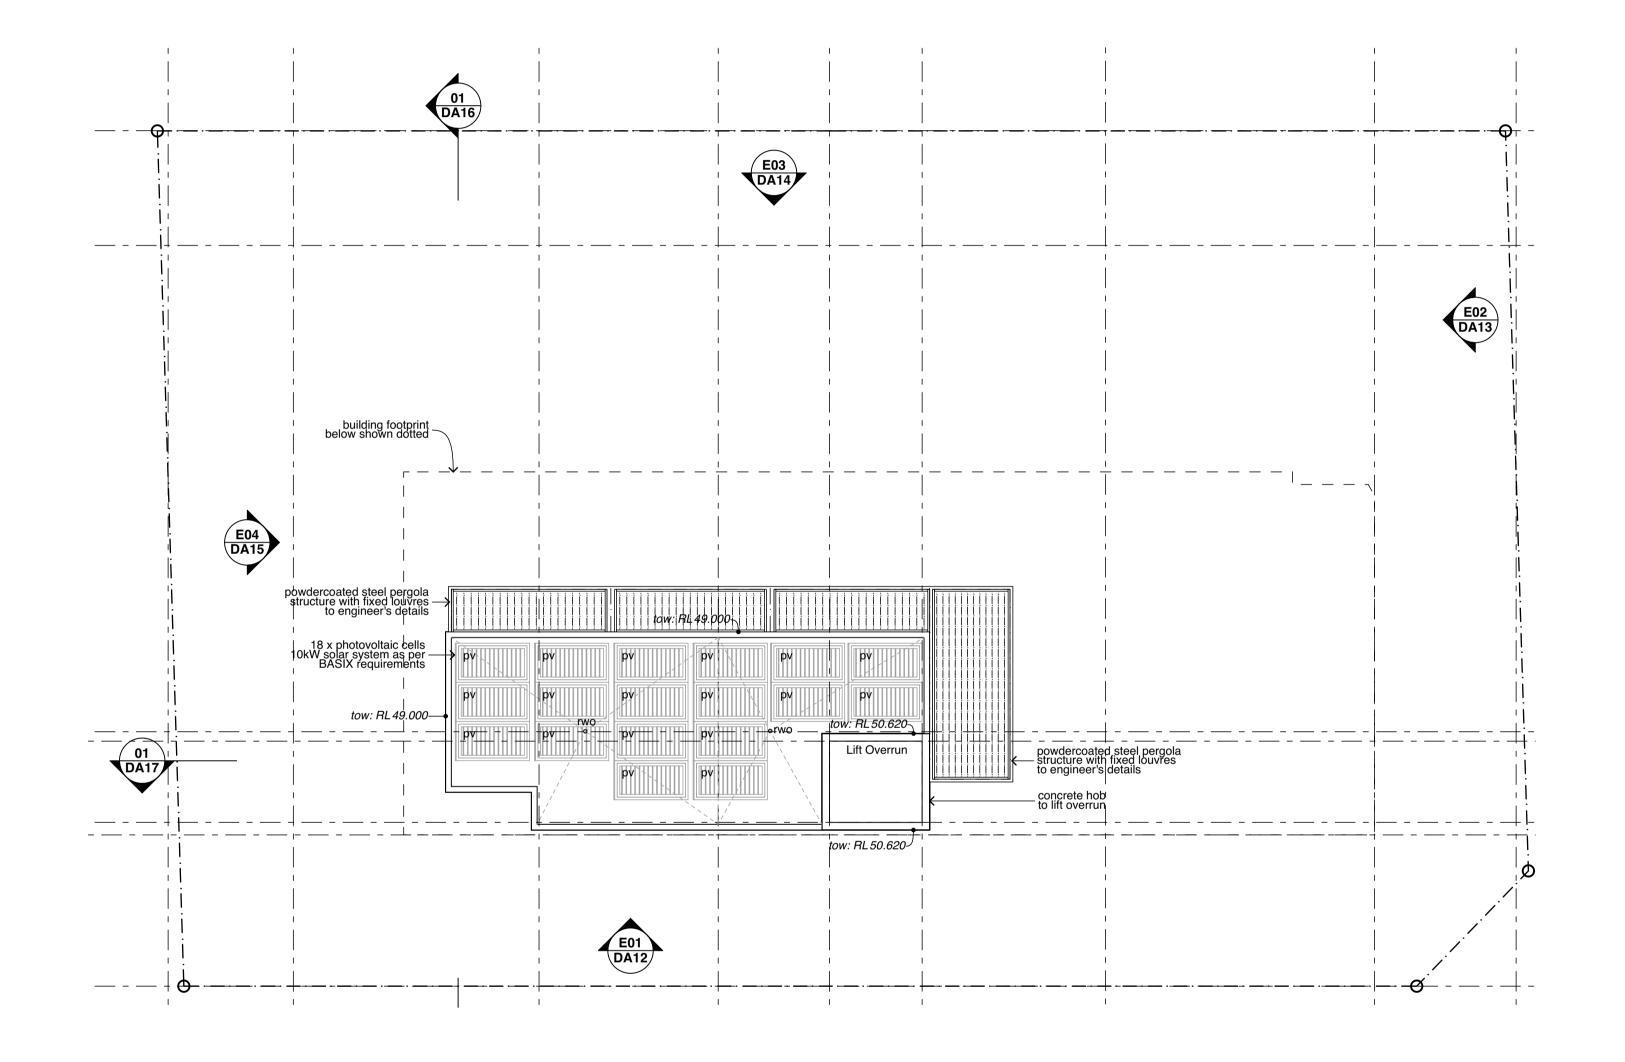

Legend (roof plans)
note: drawing may not contain all items listed below
ap access panel
bc barge capping
dp downpipe
eg eaves gutter
ex. existing
fg flashing
gu gutter
mdr metal deck roof sheeting
of overflow

parapet capping photovoltaic cells

rrc roof ridge capping
rwh rainwater head
sk skylight/skytube
tf tray flashing
vg valley gutter
vof vertical overflow
vp vent pipe

provide flashings and cappings to all roof penetrations in accordance with roof manufacturers details
 gutter on brackets as specified.
 roof safety system to be installed. refer to specification
 provide gutter-guards to all guttering throughout refer to reference specification for 'group homes' construction adhc august 2012
 metal roof sheeting to comply with AS1562.1

gutters, downpipes and flashing must comply with AS/NZ 2179.1 and AS1273 and not contain any lead for potable water supplies. The roof water is not proposed to be used for potable water supply.
 down pipe sizes are required to satisfy the requirements of BCA 3.5.2.5

8. the fire hazard properties of materials used must comply with the following;
(a) sacking-type materials used in the roof must have a flammability index not greater than 5.
(b) flexible ductwork used for the transfer of products initiating from a heat source that contains a flame must comply with the fire hazard properties set out in AS4254.

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Hume Community Housing

Residential Apartments

23-25 Charles Street, Liverpool, NSW

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Project No; 2827.22

Drawing No; DA11

Revision#;

04

Roof Plan

E01 East Elevation (Charles Street)



Legend (elevation & sections)

aluminium framed window balustrade (type) barge capping box gutter brick header course

brick on edge

brickwork sill

control joint

compessed fibre cement

door head eaves gutter existing ground line fixed sash window face brickwork (type) finished ceiling level finished floor level

feature panel

handrail (type) hot water unit insulated panel fixed louvres operable louvres metal cladding (type) metal deck roof off form concrete operable louvres

paint (type)

perforated acoustic panel (type) plasterboard privacy screen photovoltaic cells rendered concrete raked metal soffit render & paint finish (type) roller shutter retaining wall

rainwater head

steel column

sliding sash window


aluminium angle.

skylight/skytube sliding door sun shade (type) timber skirting window casing note:

1. all handrails, balustrades & louvres shown indicatively only. refer to detail drawings for clarity.

2. refer to engineer's drawings for final co-ordination.


3. acoustic panel edges at all major joints (solid line) & all exposed edges including top (adjoining s/s sill) & bottom (adjoining skirting) are to include 12x12mm angle.

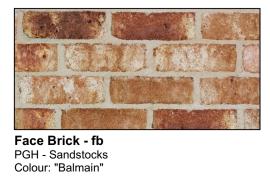

External Finishes:



Colour: "Original"

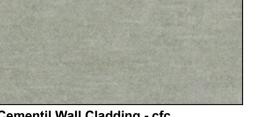



Colour: "Lexicon"

Window & Door Frames To Match Colorbond

Colour: "Night Sky"

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Hume Community Housing

Residential Apartments

23-25 Charles Street, Liverpool, NSW

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Project No; 2827.22

Drawing No; Revision#; DA12 04

East Elevation (Charles Street)

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	S4.55 Submission in	
04	Response to Council	
	_	

Comments







Hume Community Housing

Residential Apartments

23-25 Charles Street, Liverpool, NSW

Drawn; jok Checked; jok Plot date; 1/9/2023

Scale;1:100 as noted @ AI


Project No; 2827.22

Drawing No; DA13

North Elevation Mill

Revision#;

04

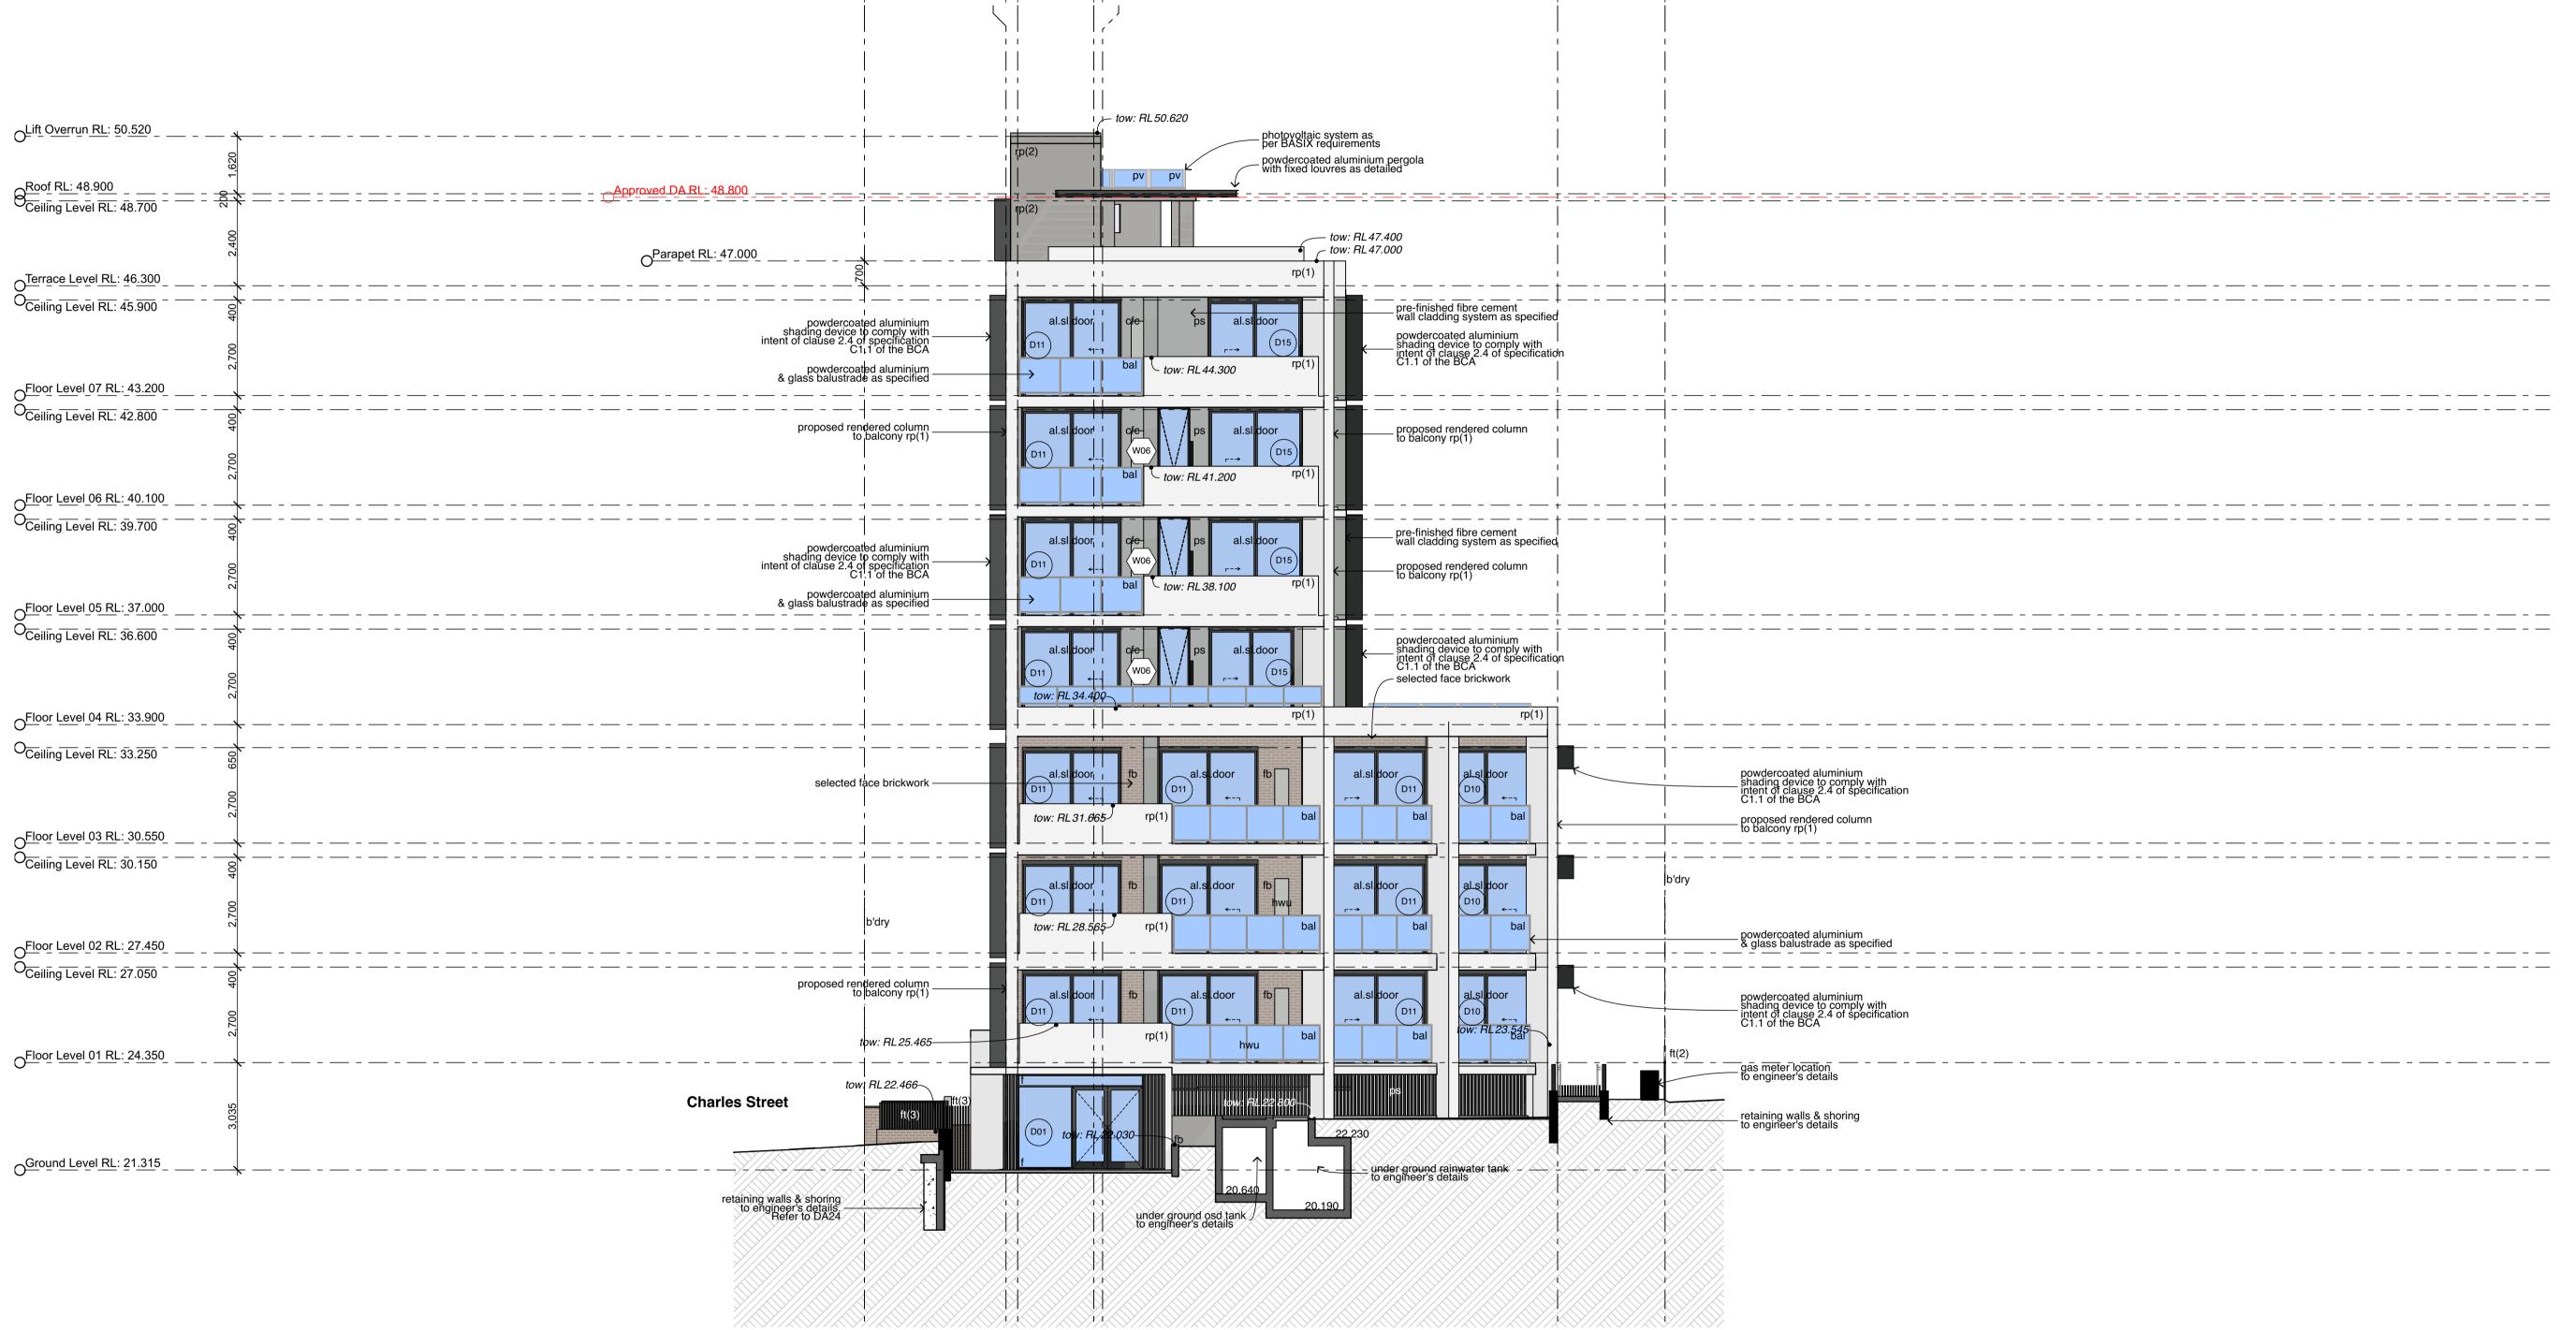



Legend (elevation & sections) aluminium framed window

brick on edge

brickwork sill

control joint

North Elevation (Mill Road)

balustrade (type) barge capping box gutter brick header course

coved skirting door head eaves gutter existing ground line fixed sash window face brickwork (type) finished ceiling level compessed fibre cement finished floor level

feature panel

handrail (type) hot water unit insulated panel fixed louvres operable louvres metal cladding (type) metal deck roof off form concrete

operable louvres

paint (type)

perforated acoustic panel (type) plasterboard privacy screen photovoltaic cells rendered concrete raked metal soffit render & paint finish (type) roller shutter

retaining wall

steel column

rainwater head

sliding sash window

skylight/skytube sliding door sun shade (type) timber skirting window casing

 all handrails, balustrades & louvres shown indicatively only, refer to detail drawings for clarity. 2. refer to engineer's drawings for final co-ordination.
3. acoustic panel edges at all major joints (solid line) & all exposed edges including top (adjoining s/s sill) & bottom (adjoining skirting) are to include 12x12mm aluminium angle.



External Finishes:

PGH - Sandstocks

Colour: "Balmain"





Colour: "Original"



Window & Door Frames To Match Colorbond Colour: "Night Sky" Road)

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Hume Community Housing

Residential Apartments

23-25 Charles Street, Liverpool, NSW

Drawn; jok Checked; jok Plot date; 1/9/2023

Scale;1:100 as noted @ AI

Project No; 2827.22

Drawing No; Revision#; **DA14** 04

West Elevation

External Finishes:












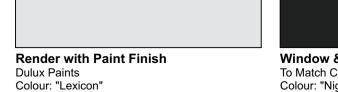





West Elevation

Legend (elevation & sections)

brickwork sill

control joint

aluminium framed window balustrade (type) barge capping box gutter brick header course brick on edge

compessed fibre cement

door head eaves gutter existing ground line fixed sash window face brickwork (type) finished ceiling level finished floor level feature panel

coved skirting

handrail (type) hot water unit insulated panel fixed louvres operable louvres metal cladding (type) metal deck roof

off form concrete

operable louvres

paint (type)

perforated acoustic panel (type) plasterboard privacy screen photovoltaic cells rendered concrete raked metal soffit roller shutter retaining wall

steel column

render & paint finish (type) rainwater head sliding sash window

sliding door sun shade (type) timber skirting window casing note:
1. all handrails, balustrades & louvres shown indicatively only. refer to detail drawings for clarity.
2. refer to engineer's drawings for final co-ordination.
3. acoustic panel edges at all major joints (solid line) & all exposed edges including top (adjoining s/s sill) & bottom (adjoining skirting) are to include 12x12mm aluminium angle

aluminium angle.

skylight/skytube

Face Brick - fb PGH - Sandstocks Colour: "Balmain"

Barestone Colour: "Original"

Window & Door Frames To Match Colorbond Colour: "Night Sky"

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Hume Community Housing

Residential Apartments

23-25 Charles Street, Liverpool, NSW


Drawn; jok Checked; jok Plot date; 1/9/2023

Scale;1:100 as noted @ AI

Project No; 2827.22

Drawing No; Revision#; DA15 04

South Elevation

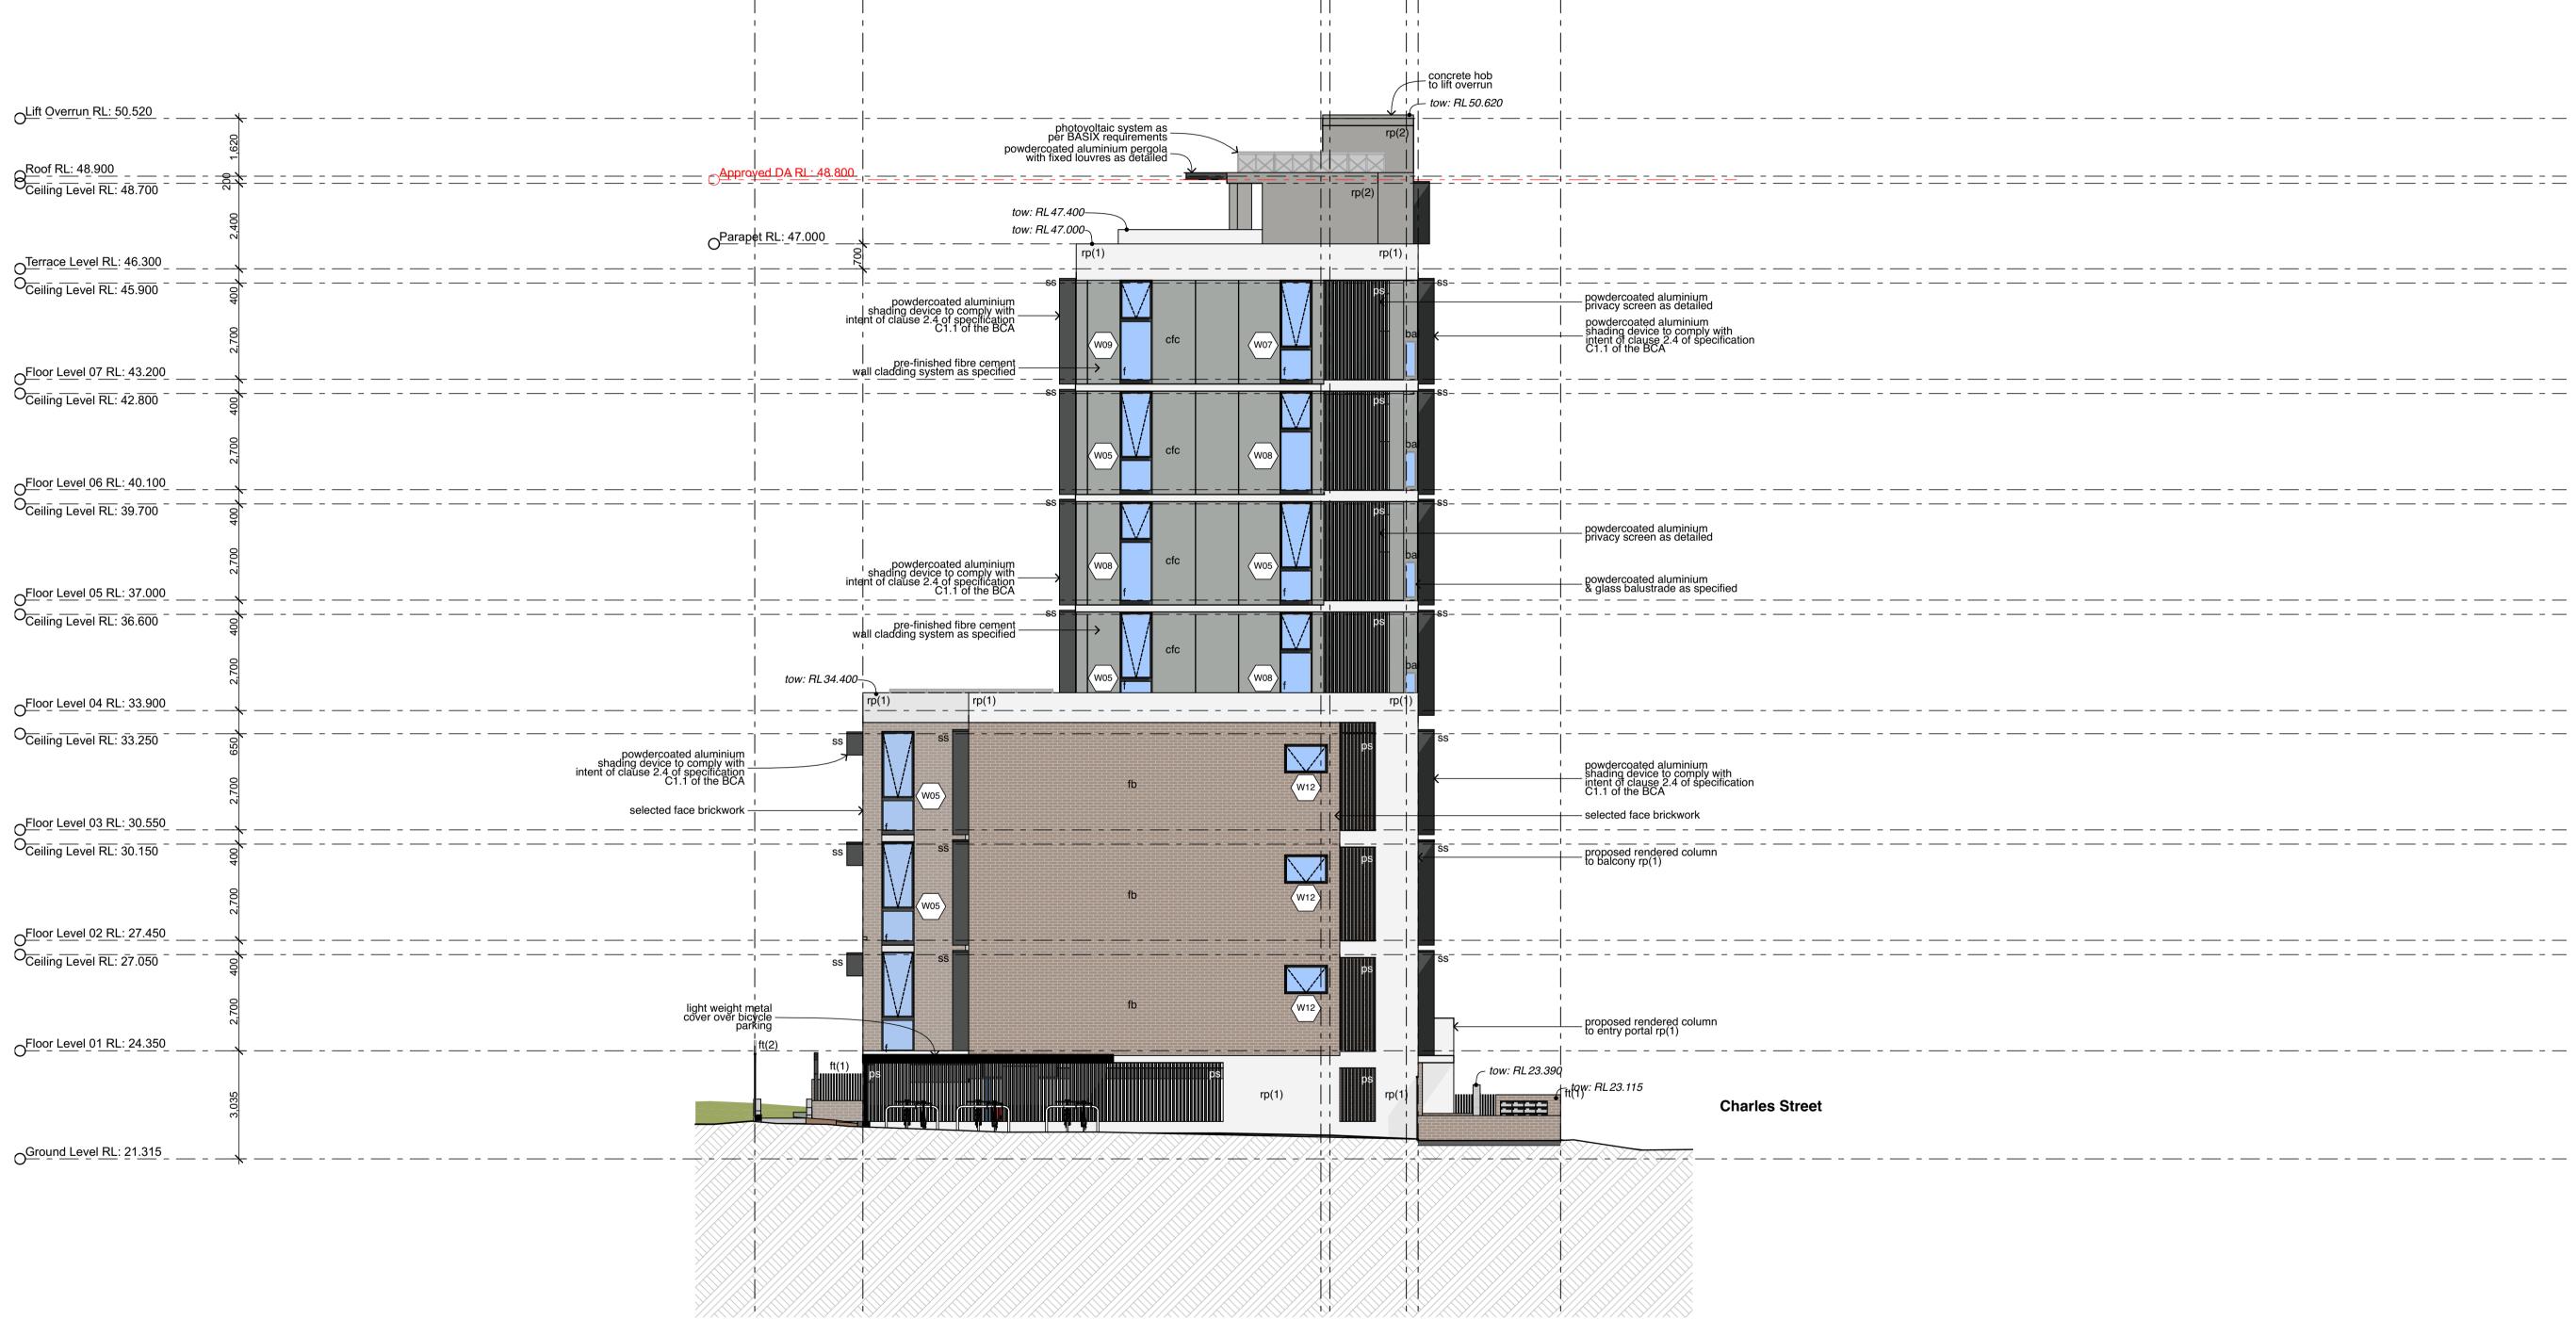

skylight/skytube

sun shade (type)

timber skirting

window casing

aluminium angle.

note:

1. all handrails, balustrades & louvres shown indicatively only. refer to detail drawings for clarity.

2. refer to engineer's drawings for final co-ordination.

3. acoustic panel edges at all major joints (solid line) & all exposed edges including top (adjoining s/s sill) & bottom (adjoining skirting) are to include 12x12mm angle.

sliding door

perforated acoustic panel (type)

plasterboard

privacy screen

photovoltaic cells

rendered concrete

raked metal soffit

roller shutter

retaining wall

steel column

rainwater head

sliding sash window

render & paint finish (type)

External Finishes:

Face Brick - fb

PGH - Sandstocks Colour: "Balmain"

Cementil Wall Cladding - cfc

Barestone

Colour: "Original"

Render with Paint Finish

Dulux Paints

Colour: "Lexicon"

Window & Door Frames

To Match Colorbond

Colour: "Night Sky"

South Elevation

Legend

(elevation & sections)

aluminium framed window

balustrade (type)

brick header course

compessed fibre cement

barge capping

brick on edge

brickwork sill

control joint

box gutter

ground line

handrail (type)

hot water unit

fixed louvres

insulated panel

operable louvres

metal deck roof

off form concrete

operable louvres

paint (type)

metal cladding (type)

coved skirting

door head

eaves gutter

existing ground line

fixed sash window

face brickwork (type)

finished ceiling level

finished floor level

feature panel

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Hume Community Housing

Community Housing

Residential Apartments

23-25 Charles Street, Liverpool, NSW

Drawn; jok Checked; jok Plot date; 1/9/2023

Scale;1:100 as noted @ AI

Project No; 2827.22

Drawing No; Revision#; DA16 04

Section 01

Window & Door Frames


External Finishes:

photovoltaic system as per BASIX requirements

_ tow: RL34.400






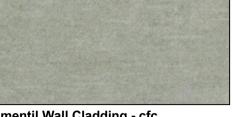







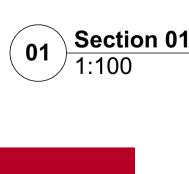

ORoof Terrace RL: 46.300

Oceiling Level RL: 45.900

O_{Ceiling Level RL: 42.800}

OFloor Level 06 RL: 40.100 Oceiling Level RL: 39.700

Floor Level 05 RL: 37.000

Floor Level 04 RL: 33.900

Oceiling Level RL: 33.250

OFloor Level 03 RL: 30.550

OFloor Level 02 RL: 27.450 Oceiling Level RL: 27.050

OFloor Level 01 RL: 24.350

Parking Undercorft RL: 21.315

Legend (elevation & sections) aluminium framed window balustrade (type) barge capping

brickwork sill

control joint

compessed fibre cement

box gutter brick header course brick on edge

coved skirting door head eaves gutter existing ground line fixed sash window face brickwork (type) finished ceiling level finished floor level

feature panel

ground line handrail (type) hot water unit insulated panel fixed louvres operable louvres metal cladding (type) metal deck roof off form concrete

operable louvres

paint (type)

powdercoated aluminium & glass balustrade as specified

plasterboard privacy screen raked metal soffit roller shutter retaining wall

rainwater head

steel column

sliding sash window

tow: RL 28.550-

tow: RL 25.450~

tow: RL 49.000-

concrete hob _ to lift overrun

tow: RL 47.000-

perforated acoustic panel (type) photovoltaic cells rendered concrete render & paint finish (type)

sun shade (type) timber skirting window casing

skylight/skytube

sliding door

note:
1. all handrails, balustrades & louvres shown indicatively only. refer to detail drawings for clarity.
2. refer to engineer's drawings for final co-ordination.
3. acoustic panel edges at all major joints (solid line) & all exposed edges including top (adjoining s/s sill) & bottom (adjoining skirting) are to include 12x12mm aluminium angle.

_ photovoltaic system as per BASIX requirements

Roof Terrace

Living/Dining Room

ving/Dining Room

Living/Dining Room

Living/Dining Room\/

Wc

powdercoated aluminium pergola with fixed louvres as detailed

- tow: RL 47.400

_ tow: RL 47.000

Bed 2

Bed 2

Bed 2

Face Brick - fb PGH - Sandstocks Colour: "Balmain"

Barestone Colour: "Original"

selected face brickwork

powdercoated aluminium shading device to comply with intent of clause 2.4 of specification C1.1 of the BCA

Dulux Paints Colour: "Lexicon" To Match Colorbond

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Hume Community Housing

Residential Apartments

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Drawing No; Revision#; DA17 04

Section 02

External Finishes:

Face Brick - fb

PGH - Sandstocks


Colour: "Balmain"










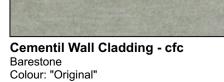

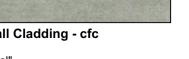







Section 02

Legend (elevation & sections)

aluminium framed window balustrade (type) barge capping

compessed fibre cement

control joint

box gutter brick header course brick on edge brickwork sill

coved skirting door head eaves gutter existing ground line fixed sash window face brickwork (type) finished ceiling level finished floor level

feature panel

ground line handrail (type) hot water unit insulated panel fixed louvres operable louvres metal cladding (type) metal deck roof off form concrete

operable louvres

paint (type)

perforated acoustic panel (type) plasterboard privacy screen photovoltaic cells rendered concrete raked metal soffit render & paint finish (type) roller shutter retaining wall rainwater head

sliding sash window

steel column

sun shade (type) timber skirting window casing

skylight/skytube sliding door


note:
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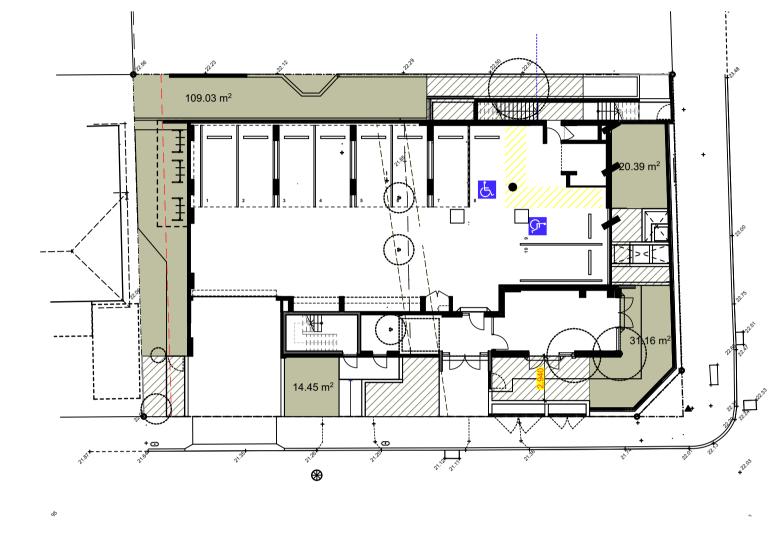
Legend
note: drawing may not contain all items listed below

note:
Green area indicates landscape
area(Ground Floor only)
Required: 30% = 240m²
Total: 265.34m² = 33%

note:
Brown area indicates deep soil zone (min. dim 3x3m)
Required: 15% = 120.3m²
Total: 175.02m² = 22%

note:
Blue area indicates Communal
Space zone
Required: 25% = 200.5m²
Total: 250.71m² = 32%




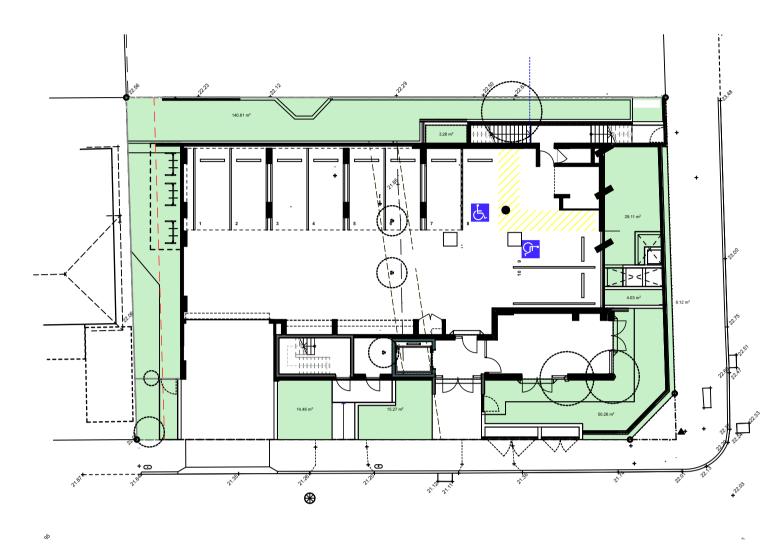


Soft landscaping - Ground Floor

Soft landscaping - Roof Terrace

02 Deep Soil Diagram

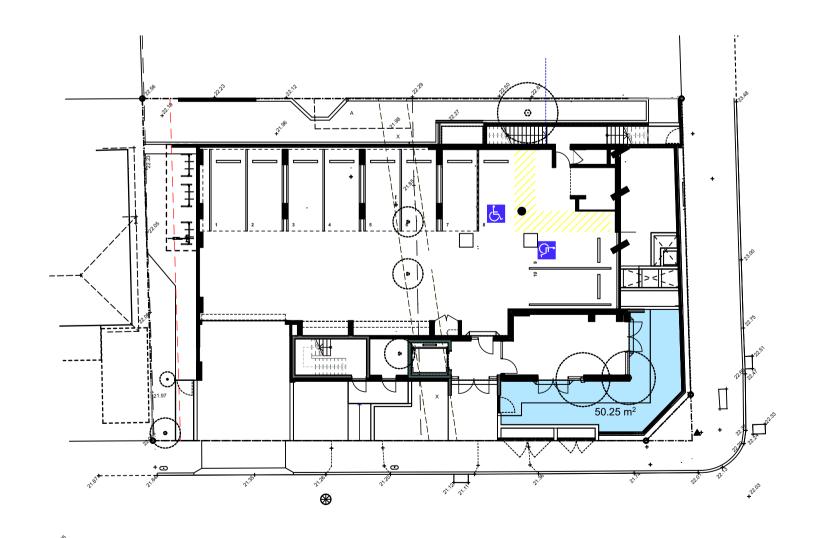

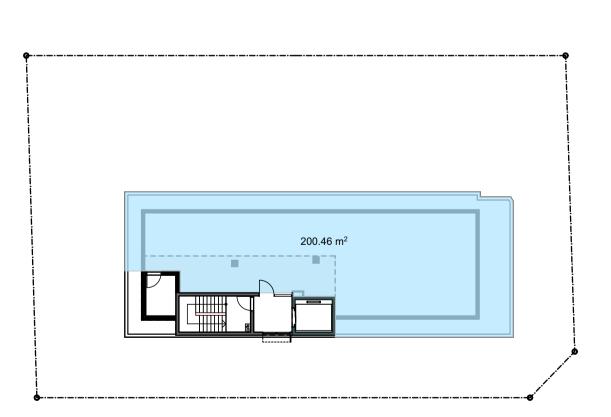

O4 Communal Space - Ground Floor 1:250

Communal Space - Roof Terrace



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Hume Community Housing

Residential Apartments

23-25 Charles Street, Liverpool, NSW

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Scale;1:250 as noted @ AI

Project No; **2827.22**


Drawing No; Revision#; DA 18 04

ADG - Soft Landscape & Deep Soil Diagram note: shadows cast: pam


note: shadows cast: 12pm

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	Meeting	
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04 Response to Council Comments

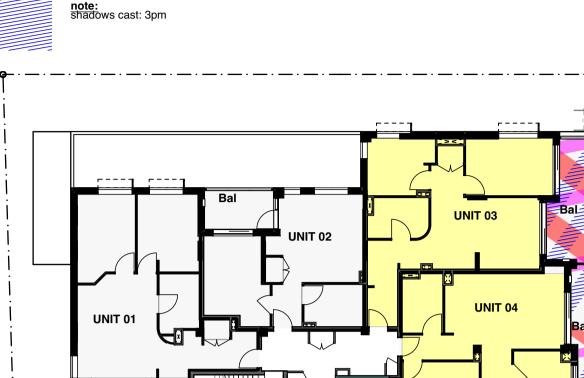


Solar Access Plan - Level 01

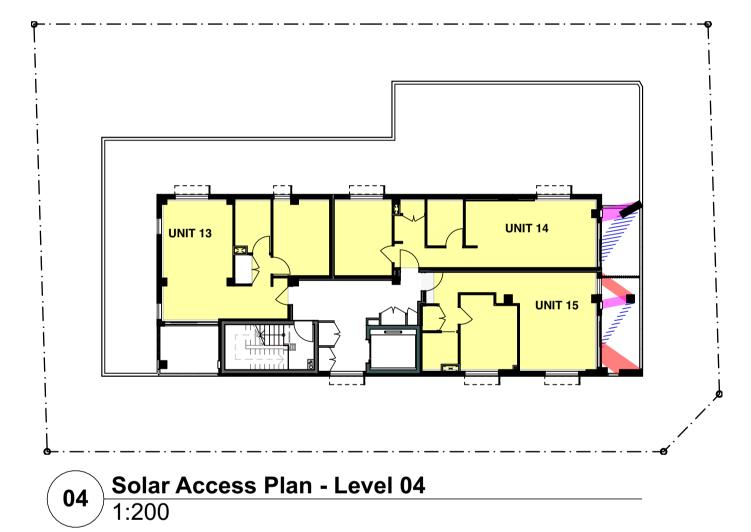


Solar Access Plan - Level 07 1:200




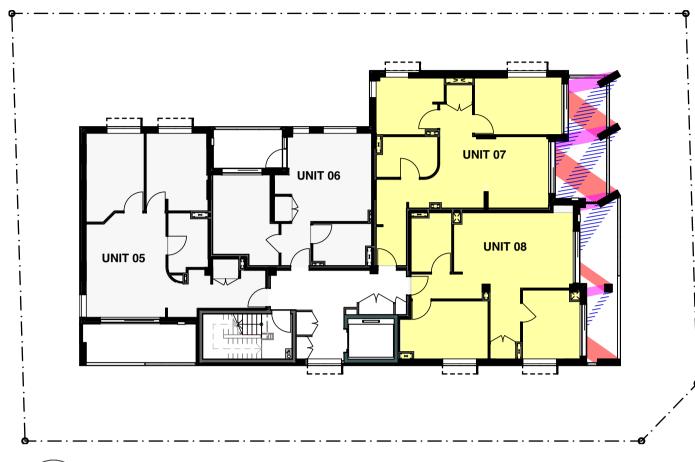

Solar Access Plan - Level 02 1:200

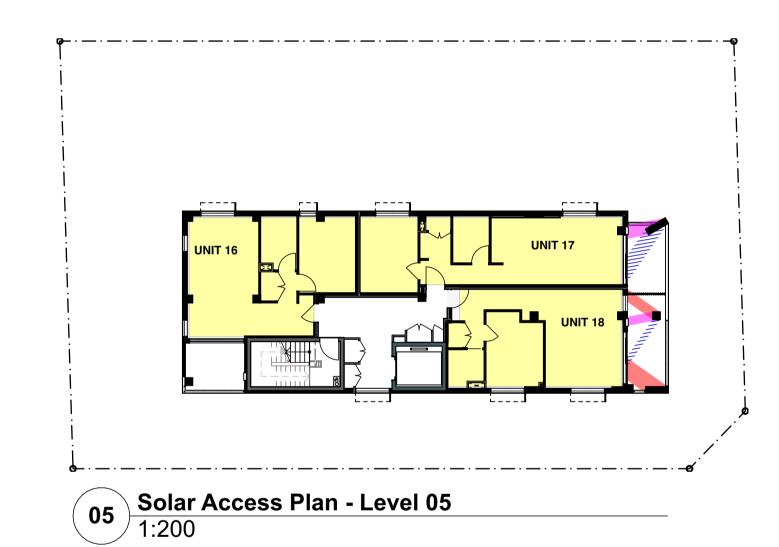

Solar Access Plan - Level 03 1:200

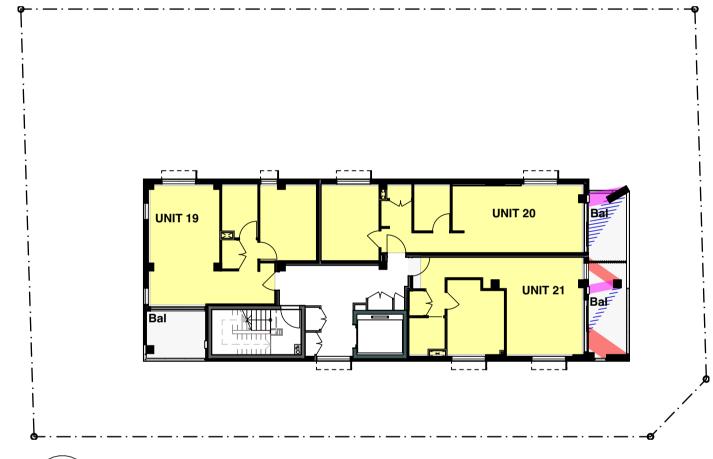

Solar Access Plan - Level 06 1:200



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Residential Apartments

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Scale;1:200 as noted @ AI


ADG COMPLIANCE - LIVING AREAS SOLAR ACCESS REQUIRED = 70% SOLAR ACCESS PROVIDED = 74%

ADG COMPLIANCE - PRIVATE OPEN SPACE SOLAR ACCESS REQUIRED = 70% SOLAR ACCESS PROVIDED = 74%

Project No; 2827.22


Drawing No; Revision#; DA19


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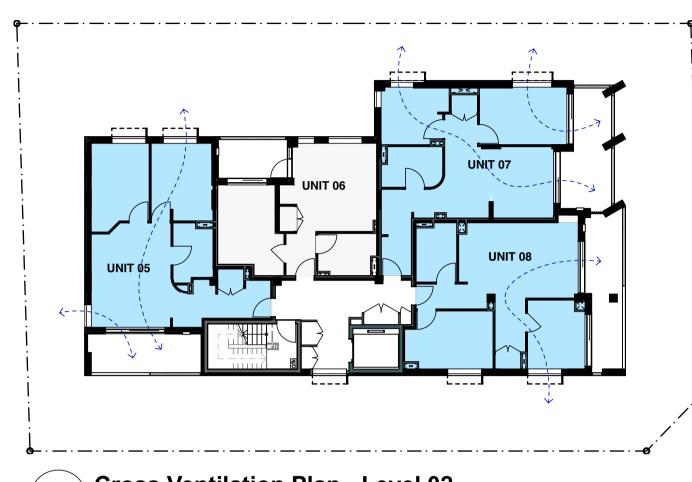


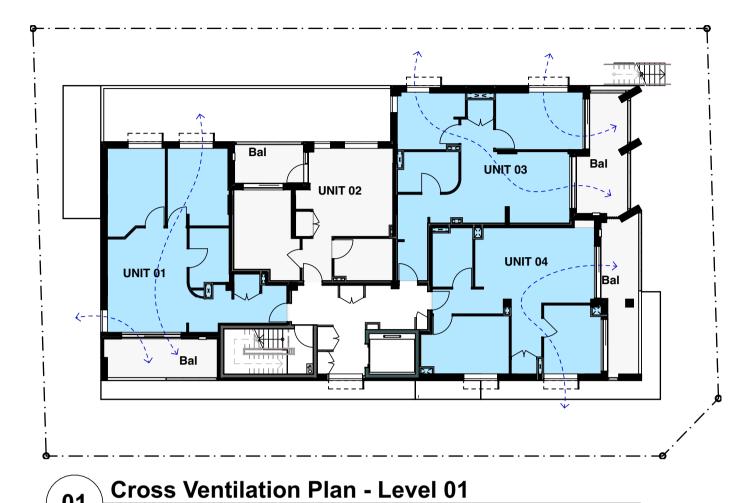
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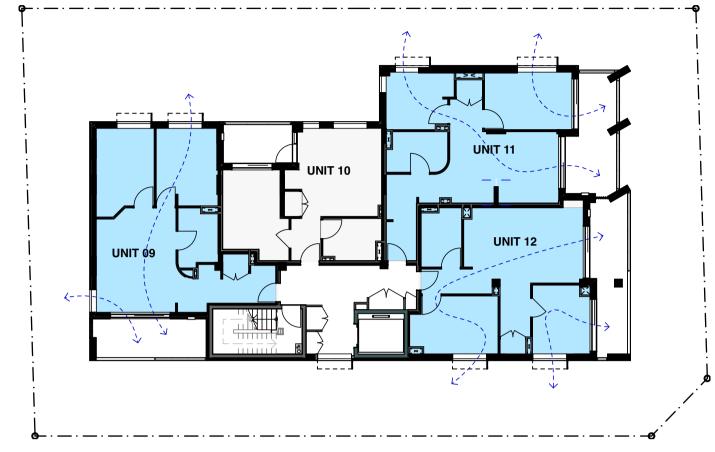







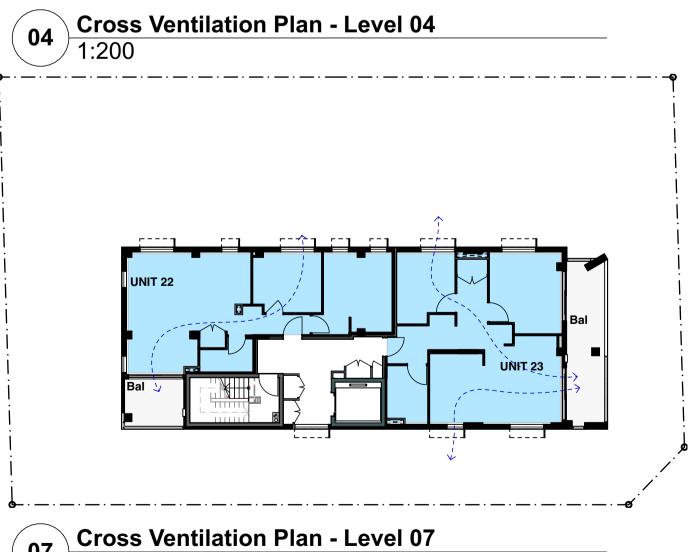

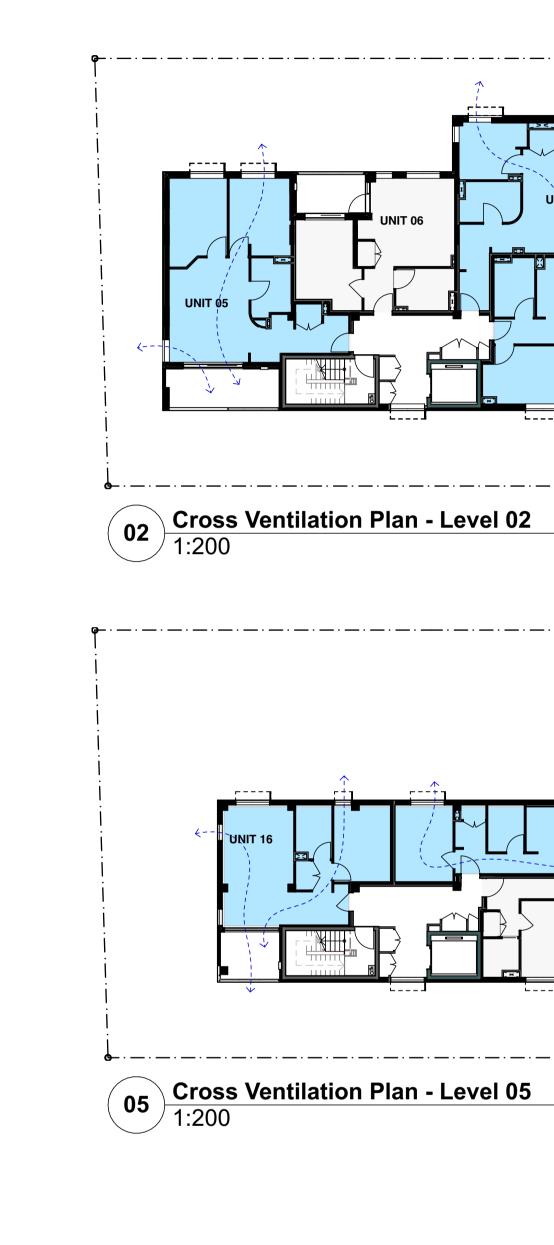

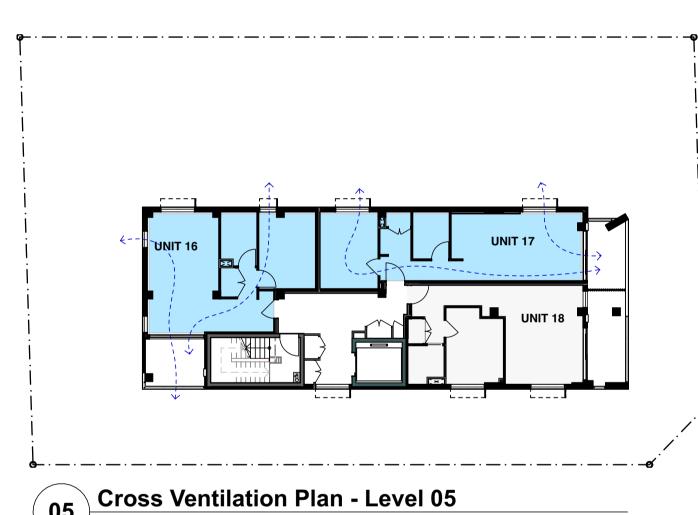



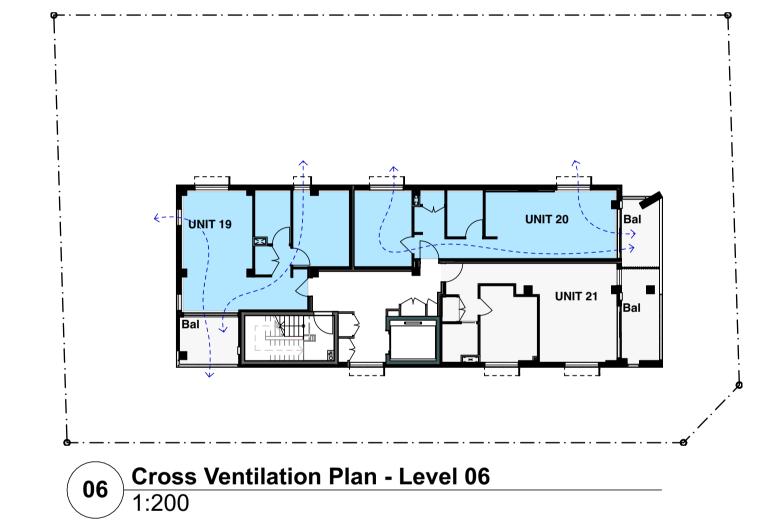



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S4.55 Submission 02 S4.55 Re Submission S4.55 Submission in 03 Response to Panel

S4.55 Submission in 04 Response to Council Comments

Meeting





Hume Community Housing

Residential Apartments

23-25 Charles Street, Liverpool, NSW

Drawn; jok Checked; jok Plot date; 1/9/2023

Scale; 1:200 as noted @ AI

Project No; 2827.22

Drawing No; Revision#; DA20





Legend shadow diagrams note: drawing may not contain all items listed below

note: shadows cast: proposed S4:55

note: shadows cast: Approved [

DP 2819 Vacant Lots
Vacant Lots DP 194873 0 33 Charles St 31 Charles St 29 Charles St 27 Charles St 35 Charles St 23-25 Charles St Charles Street 18 Mill Rd 38 Charles St 32 Charles St 34 Charles St 36 Charles St 40 Charles St 42 Charles St 44 Charles St



Proposed Shadow Diagrams @9am 1:250

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02	S4.55 Re Submission	24/05/23
03	S4.55 Submission in Response to Panel Meeting	28/06/23
04	S4.55 Submission in Response to Council Comments	







Hume Community Housing

Residential Apartments

23-25 Charles Street, Liverpool, NSW

Drawn; jok Checked; jok Plot date; 1/9/2023

Scale;1:250 as noted @ AI

Project No; 2827.22

Drawing No; DA21

Revision#;

04

Shadows - 21 June @ 9am Legend shadow diagrams note: drawing may not contain all items listed below

note: shadows cast: proposed S4:55

> note: shadows cast: Approved D

DP 2819 VACANT LOTS
(OVERGROWN LONG GRASS)

Vacant Lots DP 194873 33 Charles St 31 Charles St 27 Charles St 35 Charles St 23-25 Charles St Charles Street 18 Mill Rd 38 Charles St 32 Charles St 34 Charles St 36 Charles St 40 Charles St 42 Charles St 4 Charles St



Proposed Shadow Diagrams @12noon 1:250

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04	S4.55 Submission in Response to Council	







Hume Community Housing

Residential Apartments

23-25 Charles Street, Liverpool, NSW

Drawn; jok Checked; jok Plot date; 1/9/2023

Scale;1:250 as noted @ AI

Project No; 2827.22

Drawing No; DA22

Shadows - 21 June @ 12 noon

Revision#;

04

Legend shadow diagrams note: drawing may not contain all items listed below

note: shadows cast: proposed S4:55

> note: shadows cast: Approved [

DP 2819 VACANT LOTS (OVERGROWN LONG GRASS)

Vacant Lots 33 Charles St 31 Charles St 29 Charles St 35 Charles St 27 Charles St 23-25 Charles St Charles Street 18 Mill Rd 38 Charles St 32 Charles St 34 Charles St 36 Charles St 40 Charles St 42 Charles St 4 Charles St



O1 Proposed Shadow Diagrams @3pm 1:250

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03	Response to Panel	28/06/23
	Meeting	
	S4.55 Submission in	
04	Response to Council	
	Comments	







Hume Community Housing

Residential Apartments

23-25 Charles Street, Liverpool, NSW

Drawn; jok Checked; jok Plot date; 1/9/2023


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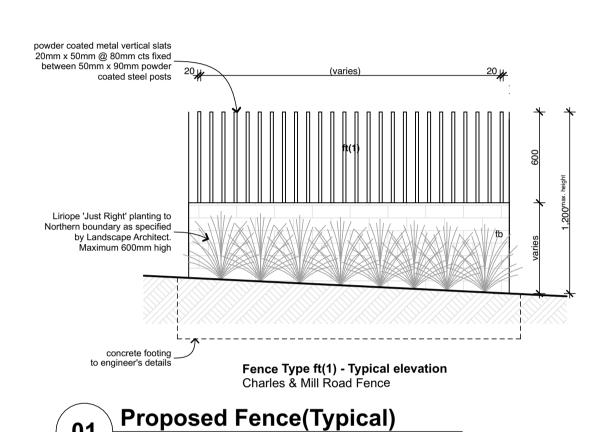
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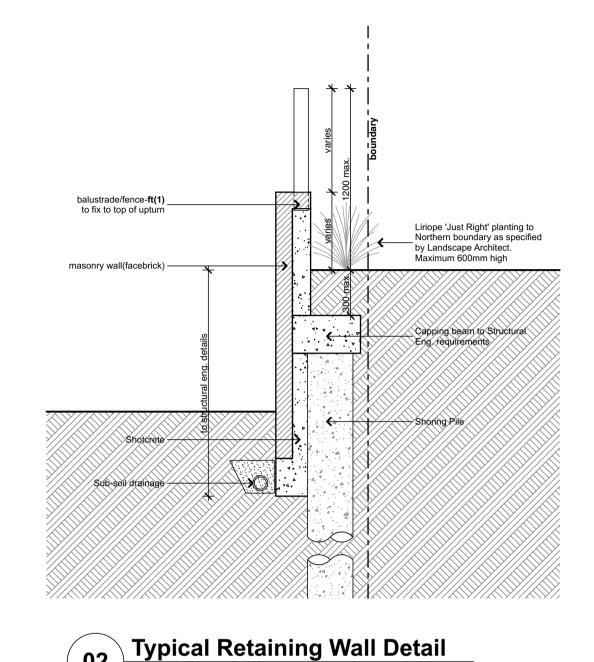
Drawing No; DA23


Shadows - 21 June @ 3pm


Revision#;







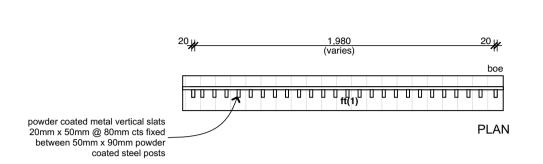


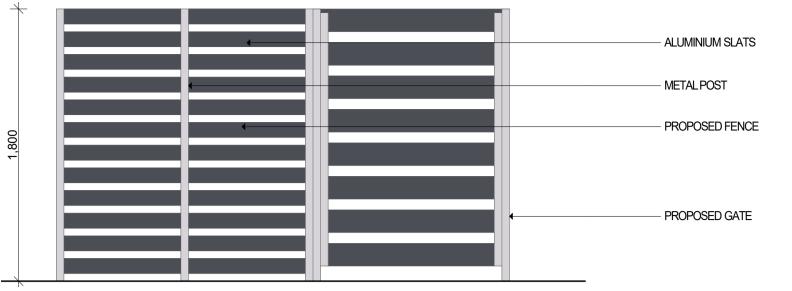

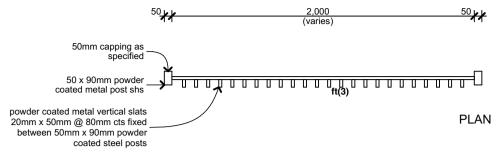


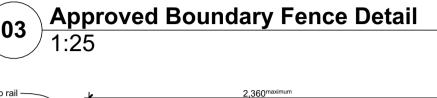

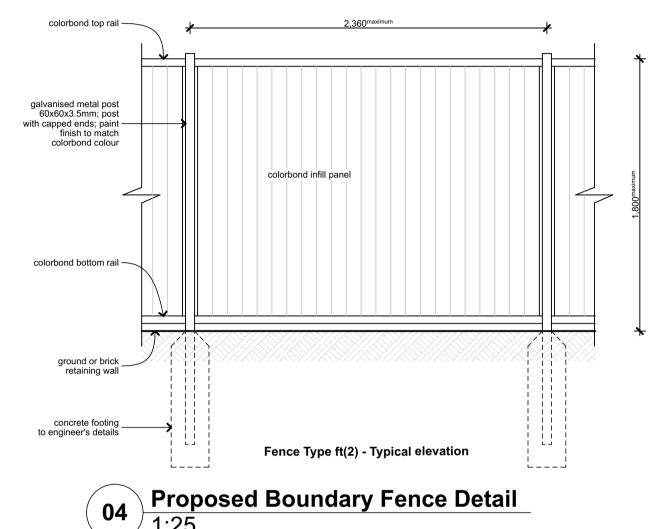


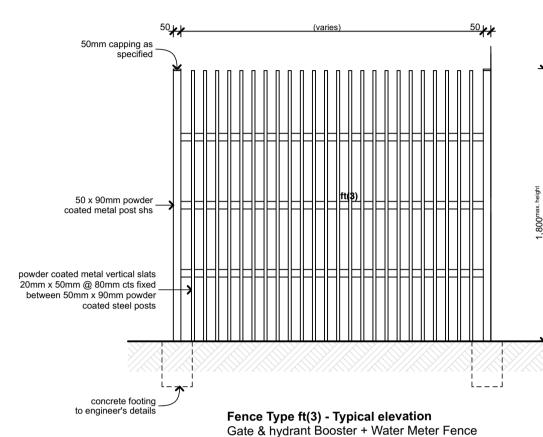


Proposed Services Fence Detail

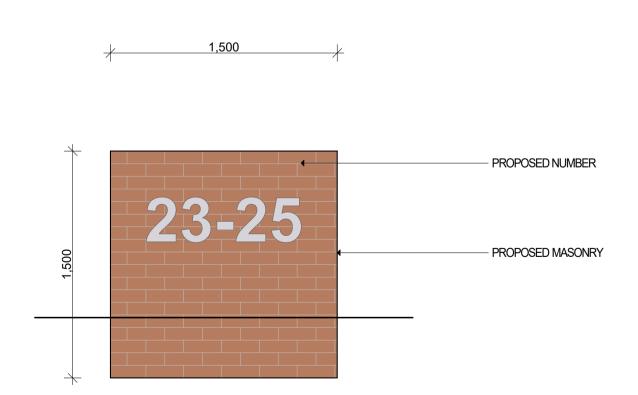




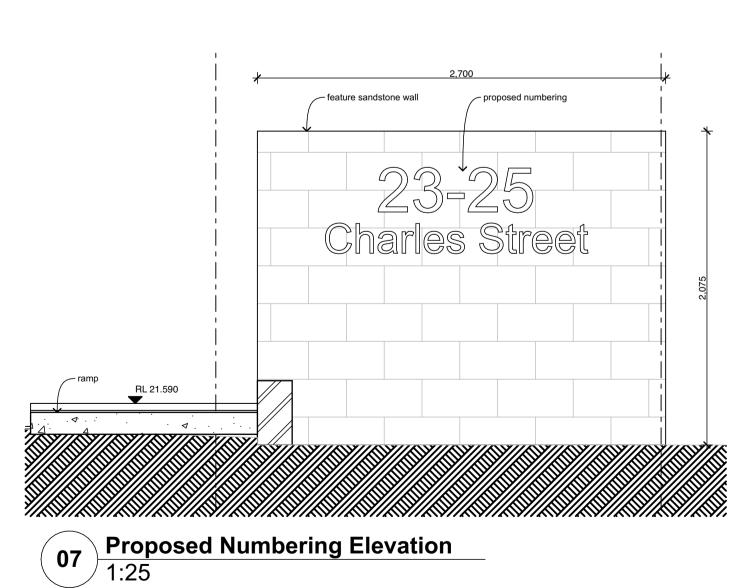

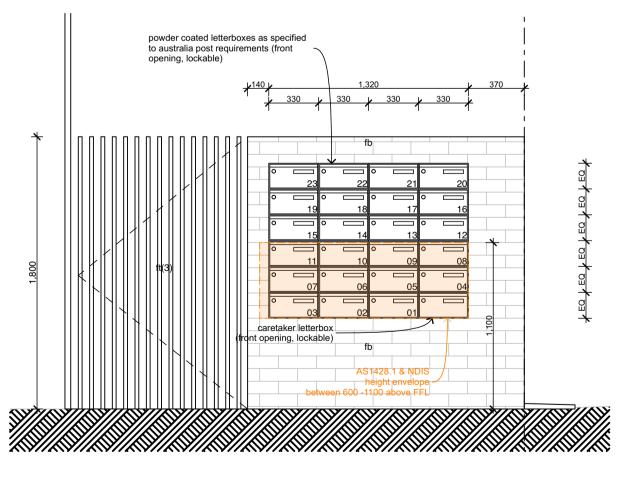

O8 Proposed Letterbox Elevation 1:25

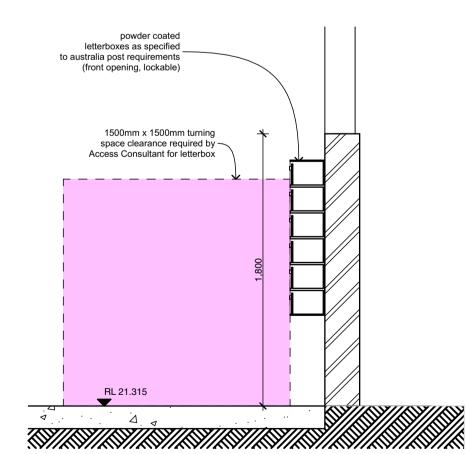

Proposed Letterbox Section1:25



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Residential Apartments

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Scale;1:25 as noted @ AI

Project No; 2827.22

Drawing No; Revision#; DA24 03

Fence and Letterbox details



			Unit	& Balcony A	reas							Unit	& Balcony A	reas			
Unit	Room Name	Beds	Min. Req. (m2)	Approved DA(m2)	Proposed S4.55(m2)	Min. Balcony Depth Req. (m)	Approved Balcony Depth(m)	Proposed Balcony Depth(m)	Unit	Room Name	Beds	Min. Req. (m2)	Approved DA(m2)	Proposed S4.55(m2)	Min. Balcony Depth Req. (m)	Approved Balcony Depth(m)	Proposed Balcony Depth(m)
Comm						()			U12						()		
	Community Room	0	N/A	31	31.23					UNIT 12	2	70	71	70.17			
U01										Bal	0	10	15	14.93	2	2.14 & 1.74	2.0 & 1.6
	UNIT 01	2	70	72	70.34				U13	<u> </u>	'		1				
	Bal	0	10	13	12.15	2	2.0	2.05		UNIT 13	1	50	52	52.40			
U02			1	1						Bal	0	8	9	8.12	2	2.65	2.
	UNIT 02	1	50	50	50.14				U14				1				
	Bal	0	8	8	8.20	2	2.0	2.05		UNIT 14	1	50	51	52.11			
U03			1	1						Bal	0	8	8	8.04	2	2.0	2.02
	UNIT 03	2	70	71	70.41				U15								
	Bal	0	10	17	14.85	2	2.12 & 2.67	2.02 & 2.72		UNIT 15	1	50	50	50.34			
U04										Bal	0	8	10	10.20	2	2.0	2.02
004	UNIT 04	2	70	71	70.17				U16		L						
	Bal	0	8	15	14.93		2.14 & 1.74	2.0 & 1.64		UNIT 16	1	50	52	52.40			
U05	Bai			10	14.00		2.14 (1.74	2.0 0 1.04		Bal	0	8	9	8.17	2	2.65	2.
000	UNIT 05	2	70	72	70.34				U17		L						
	Bal	0	10	13	12.15		2.0	2.05		UNIT 17	1	50	51	52.11			
U06	Βαι		10	10	12.10		2.0	2.00		Bal	0	8	9	8.04	2	2.0	2.02
000	UNIT 06	1	50	50	50.14				U18								
	Bal	0	8	8	8.20	2	2.0	2.05		UNIT 18	1	50	50	50.34			
U07	Βαι				0.20		2.0	2.00		Bal	0	8	11	10.00	2	2.0	2.02
007	UNIT 07	2	70	71	70.41				U19		L		ı				
	Bal	0	10	17	14.85		2.12 & 2.67	2.02 & 2.72		UNIT 19	1	50	52	52.40			
U08	Βαι		10	17	14.00		2.12 & 2.07	2.02 & 2.72		Bal	0	8	9	8.17	2	2.65	2.
000	UNIT 08	2	70	71	70.17				U20				ı				
	Bal	0	10	15	14.93		2.14 & 1.74	2.0 & 1.64		UNIT 20	1	50	51	52.11			
U09	Bai		10	1 10	14.00		2.14 (1.74	2.0 0 1.04		Bal	0	8	9	8.03	2	2.0	2.02
003	UNIT 09	2	70	72	70.34				U21				ı				
	Bal	0	10	13	12.15		2.0	2.05		UNIT 21	1	50	50	50.34			
U10	Βαι		10	10	12.10		2.0	2.00		Bal	0	8	11	10.00		2.0	2.02
010	UNIT 10	1 1	50	50	50.14				U22	I	I		<u> </u>				
	Bal	0	8	8	8.20		2.0	2.05		UNIT 22	2	70	74	75.01			
U11	Dai				0.20		2.0	2.00		Bal	0	10	10	9.10		2.65	2.
311	UNIT 11	2	70	71	70.41				U23	l		I	1			1	
	Bal	0	10	17	14.85		2.12 & 2.67	2.02 & 1.64		UNIT 23	2	70	77	82.38			
	Dai		10	17	14.00		2.12 Q 2.01	2.02 & 1.04		Bal	0	10	25	17.11		2.69	2.0



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02	Response to Panel	28/06/23
	Meeting	
	S4.55 Submission in	
03	Response to Council	
	Comments	







Residential Apartments

23-25 Charles Street, Liverpool, NSW

Drawn; jok Checked; jok Plot date; 1/9/2023

Scale;1:1 as noted @ AI

Project No; 2827.22

Drawing No; DA25

03

Revision#;

Area Calculation Tables



Photomontage 1(Proposed S4:55) - Corner Charles St and Mills Rd



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Hume Community Housing

Residential Apartments

23-25 Charles Street, Liverpool, NSW

Drawn; jok Checked; jok Plot date; 1/9/2023

Scale; as noted @ AI

Project No; 2827.22

Drawing No; DA26

Photomontage 1



Photomontage 2(Proposed S4:55) - Charles St



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Hume Community Housing

Residential Apartments

23-25 Charles Street, Liverpool, NSW

Drawn; jok Checked; jok Plot date; 1/9/2023

Scale; as noted @ AI

Project No; 2827.22

Drawing No; DA27

Photomontage 2



Photomontage 3(Proposed S4:55) - Charles St



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03	Response to Council	
	Comments	







Hume Community Housing

Residential Apartments

23-25 Charles Street, Liverpool, NSW

Drawn; jok Checked; jok Plot date; 1/9/2023


Scale; as noted @ AI

Project No; 2827.22


Drawing No; DA28

Photomontage 3



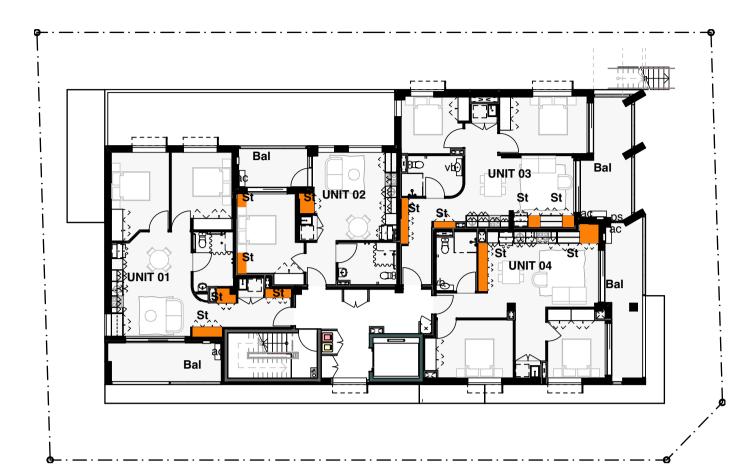

01 Floor Plan - Level 01 1:200

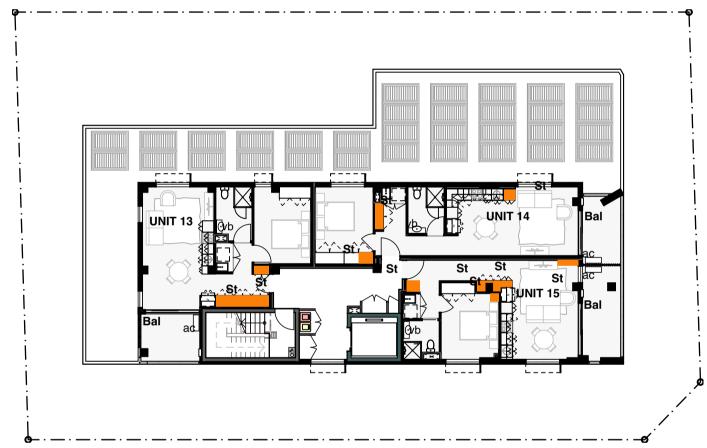

64 Floor Plan - Level 04 1:200




Floor Plan - Level 07 1:200






Floor Plan - Level 02 1:200

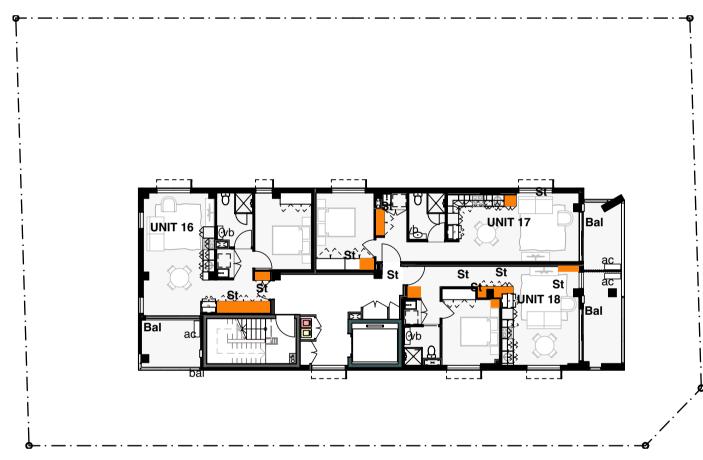


05 Floor Plan - Level 05 1:200

		Unit Sora	ge Calculatio	ns				Unit Sora	ge Calculatio	ns	
Unit Number	Beds	Name	Min. Req. (m3)	DA Approved(m3)*	Proposed S4.55(m3)	Unit Number	Beds	Name	Min. Req. (m3)	DA Approved(m3)*	Proposed S4.55(m3)
U01				,			2	St	8	2.86	5.65
	2	St	8	NIL	5.41	U13	'		-	•	
U02				•			1	St	6	2.1	5.46
	1	St	6	1.57	4.29	U14	'		-	_	
U03							1	St	6	NIL	3.82
	2	St	8	NIL	5.11	U15			•	•	•
U04			•	•			1	St	6	MIL	6.92
	2	St	8	2.86	5.65	U16			•	•	
U05			•				1	St	6	2.1	5.46
	2	St	8	NIL	5.82	U17					
U06				_			1 1	St	6	NIL	3.82
	1	St	6	1.57	4.29	U18				_	
U07							1 1	St	6	NIL	3.44
	2	St	8	NIL	5.11	U19					
U08							1 1	St	6	2.1	5.46
	2	St	8	2.86	5.65	U20					
U09							1 1	St	6	NIL	3.82
	2	St	8	NIL	5.82	U21				_	
U10							1	St	6	NIL	3.44
	1	St	6	1.57	4.29	U22					.
U11							2	St	8	NIL	6.32
	2	St	8	NIL	5.11	U23					
U12							2	St	8	NIL	6.81

*NOTE
1. DA Approved plans do not provide a breakdown of unit storage areas. Where noted "NIL", unit storage areas have not been provided.

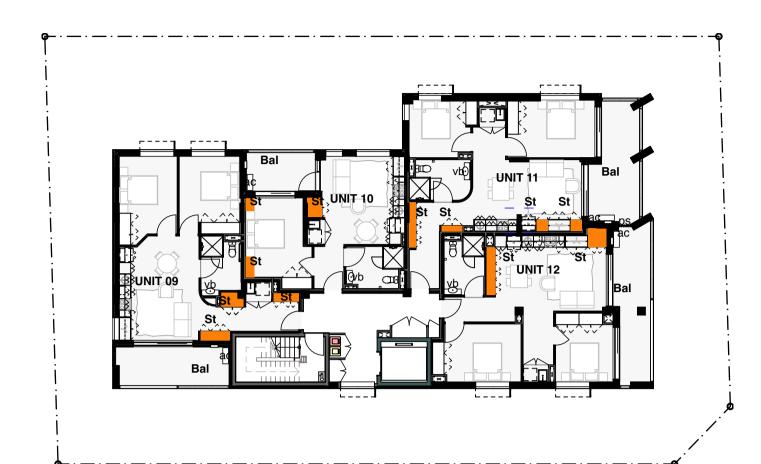

Floor Plan - Level 03 1:200

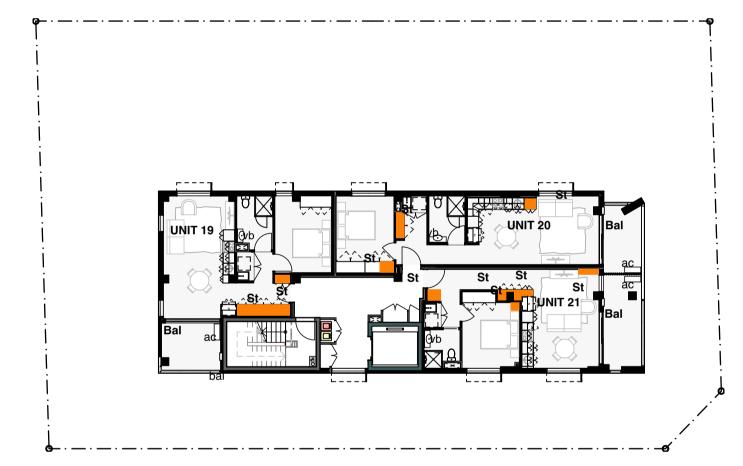

6 Floor Plan - Level 06 1:200



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Hume Community Housing

Residential Apartments

23-25 Charles Street, Liverpool, NSW

Drawn; jok Checked; jok Plot date; 1/9/2023

Scale;1:200, 1:1 as noted @ AI

Project No; 2827.22

Drawing No; Revision#; DA29 01

ADG - Storage area Plans




note: Purpl Floor


note:
Purple area indicates Proposed Gross
Floor Area





note: X area indicates riser location


note: Comms Riser - cr Hydraulic riser - hr Electric riser - er

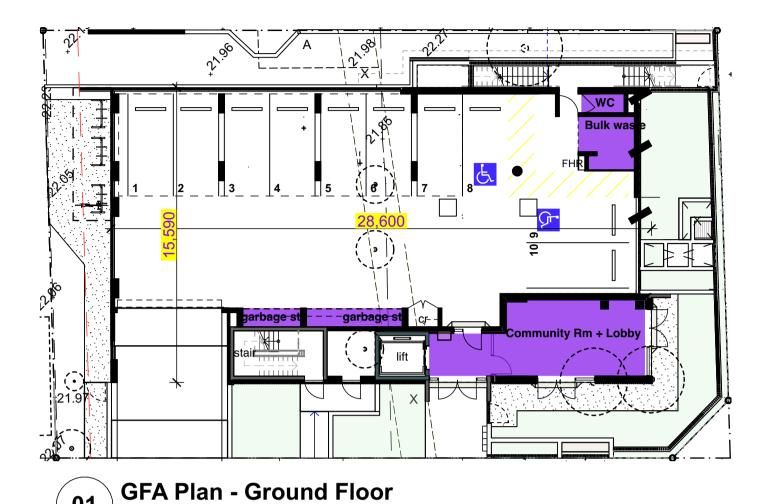

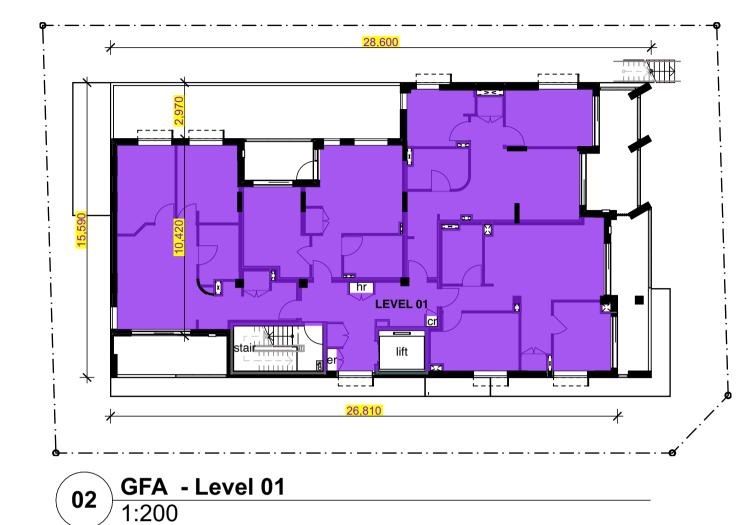


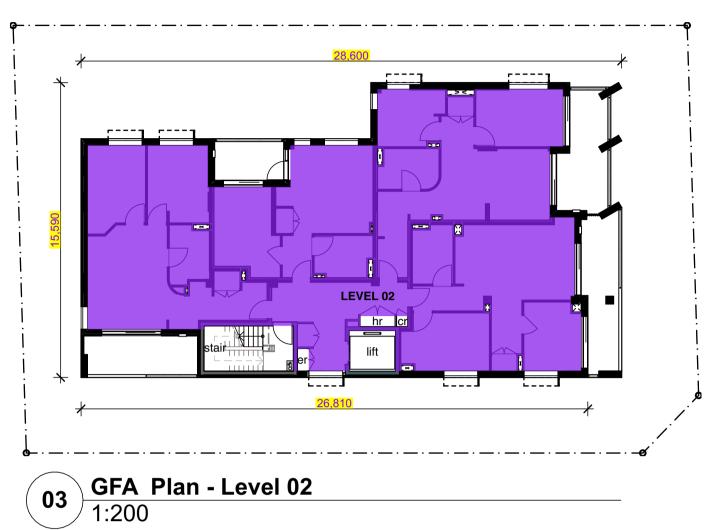


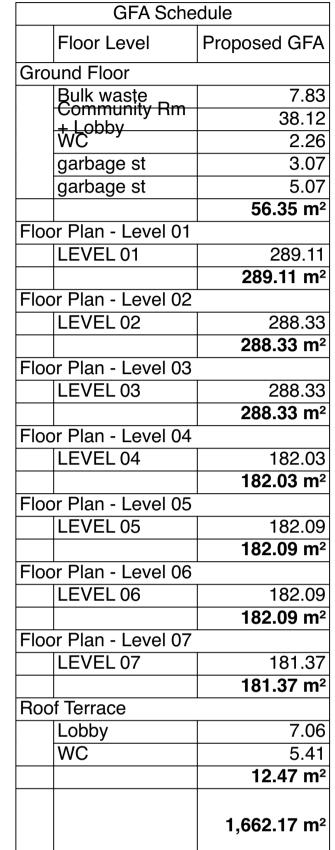

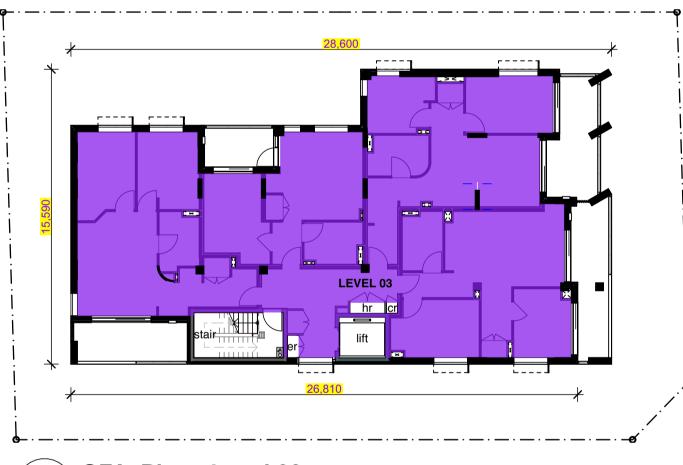



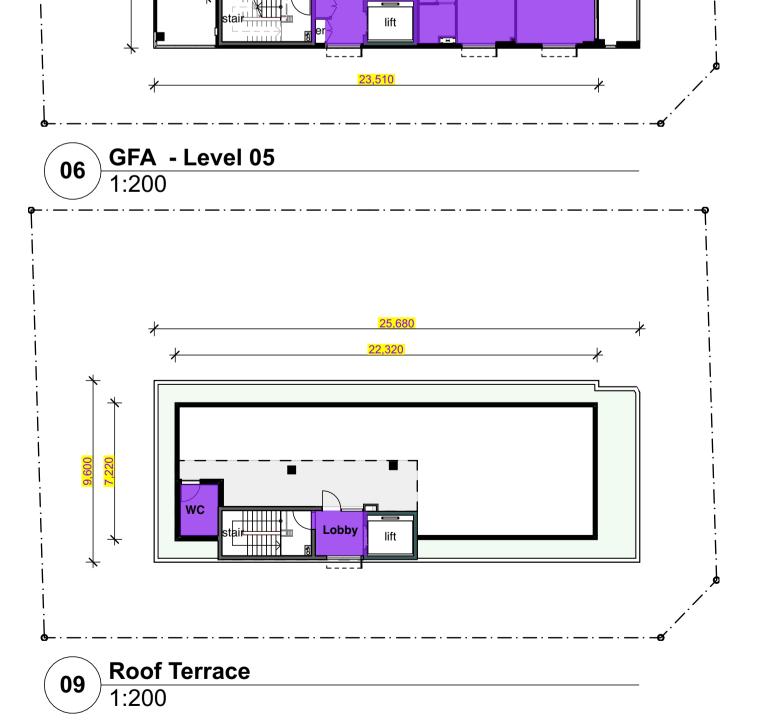

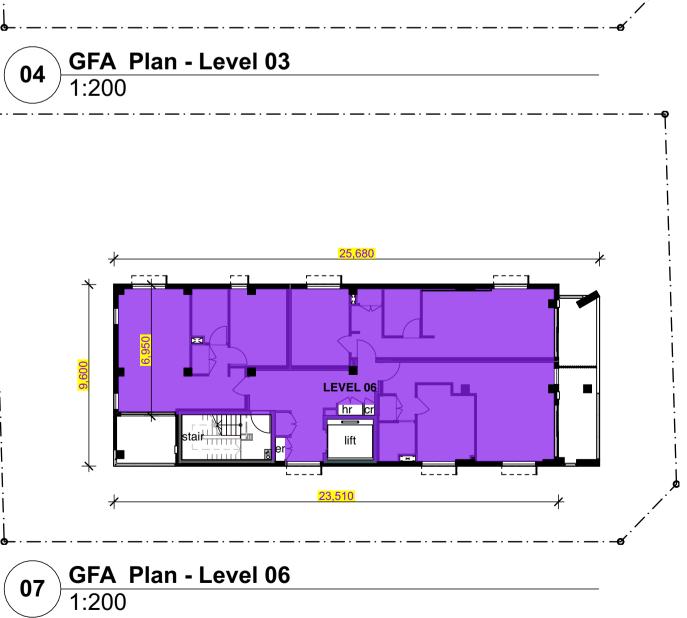





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associates pty limited.





Hume Community Housing

Residential Apartments

23-25 Charles Street, Liverpool, NSW


Drawn; jok Checked; jok Plot date; 1/9/2023

Scale;1:200, 1:1 as noted @ AI

Project No; 2827.22

Drawing No; Revision#; DA30 01


Proposed Gross Floor Area Plans

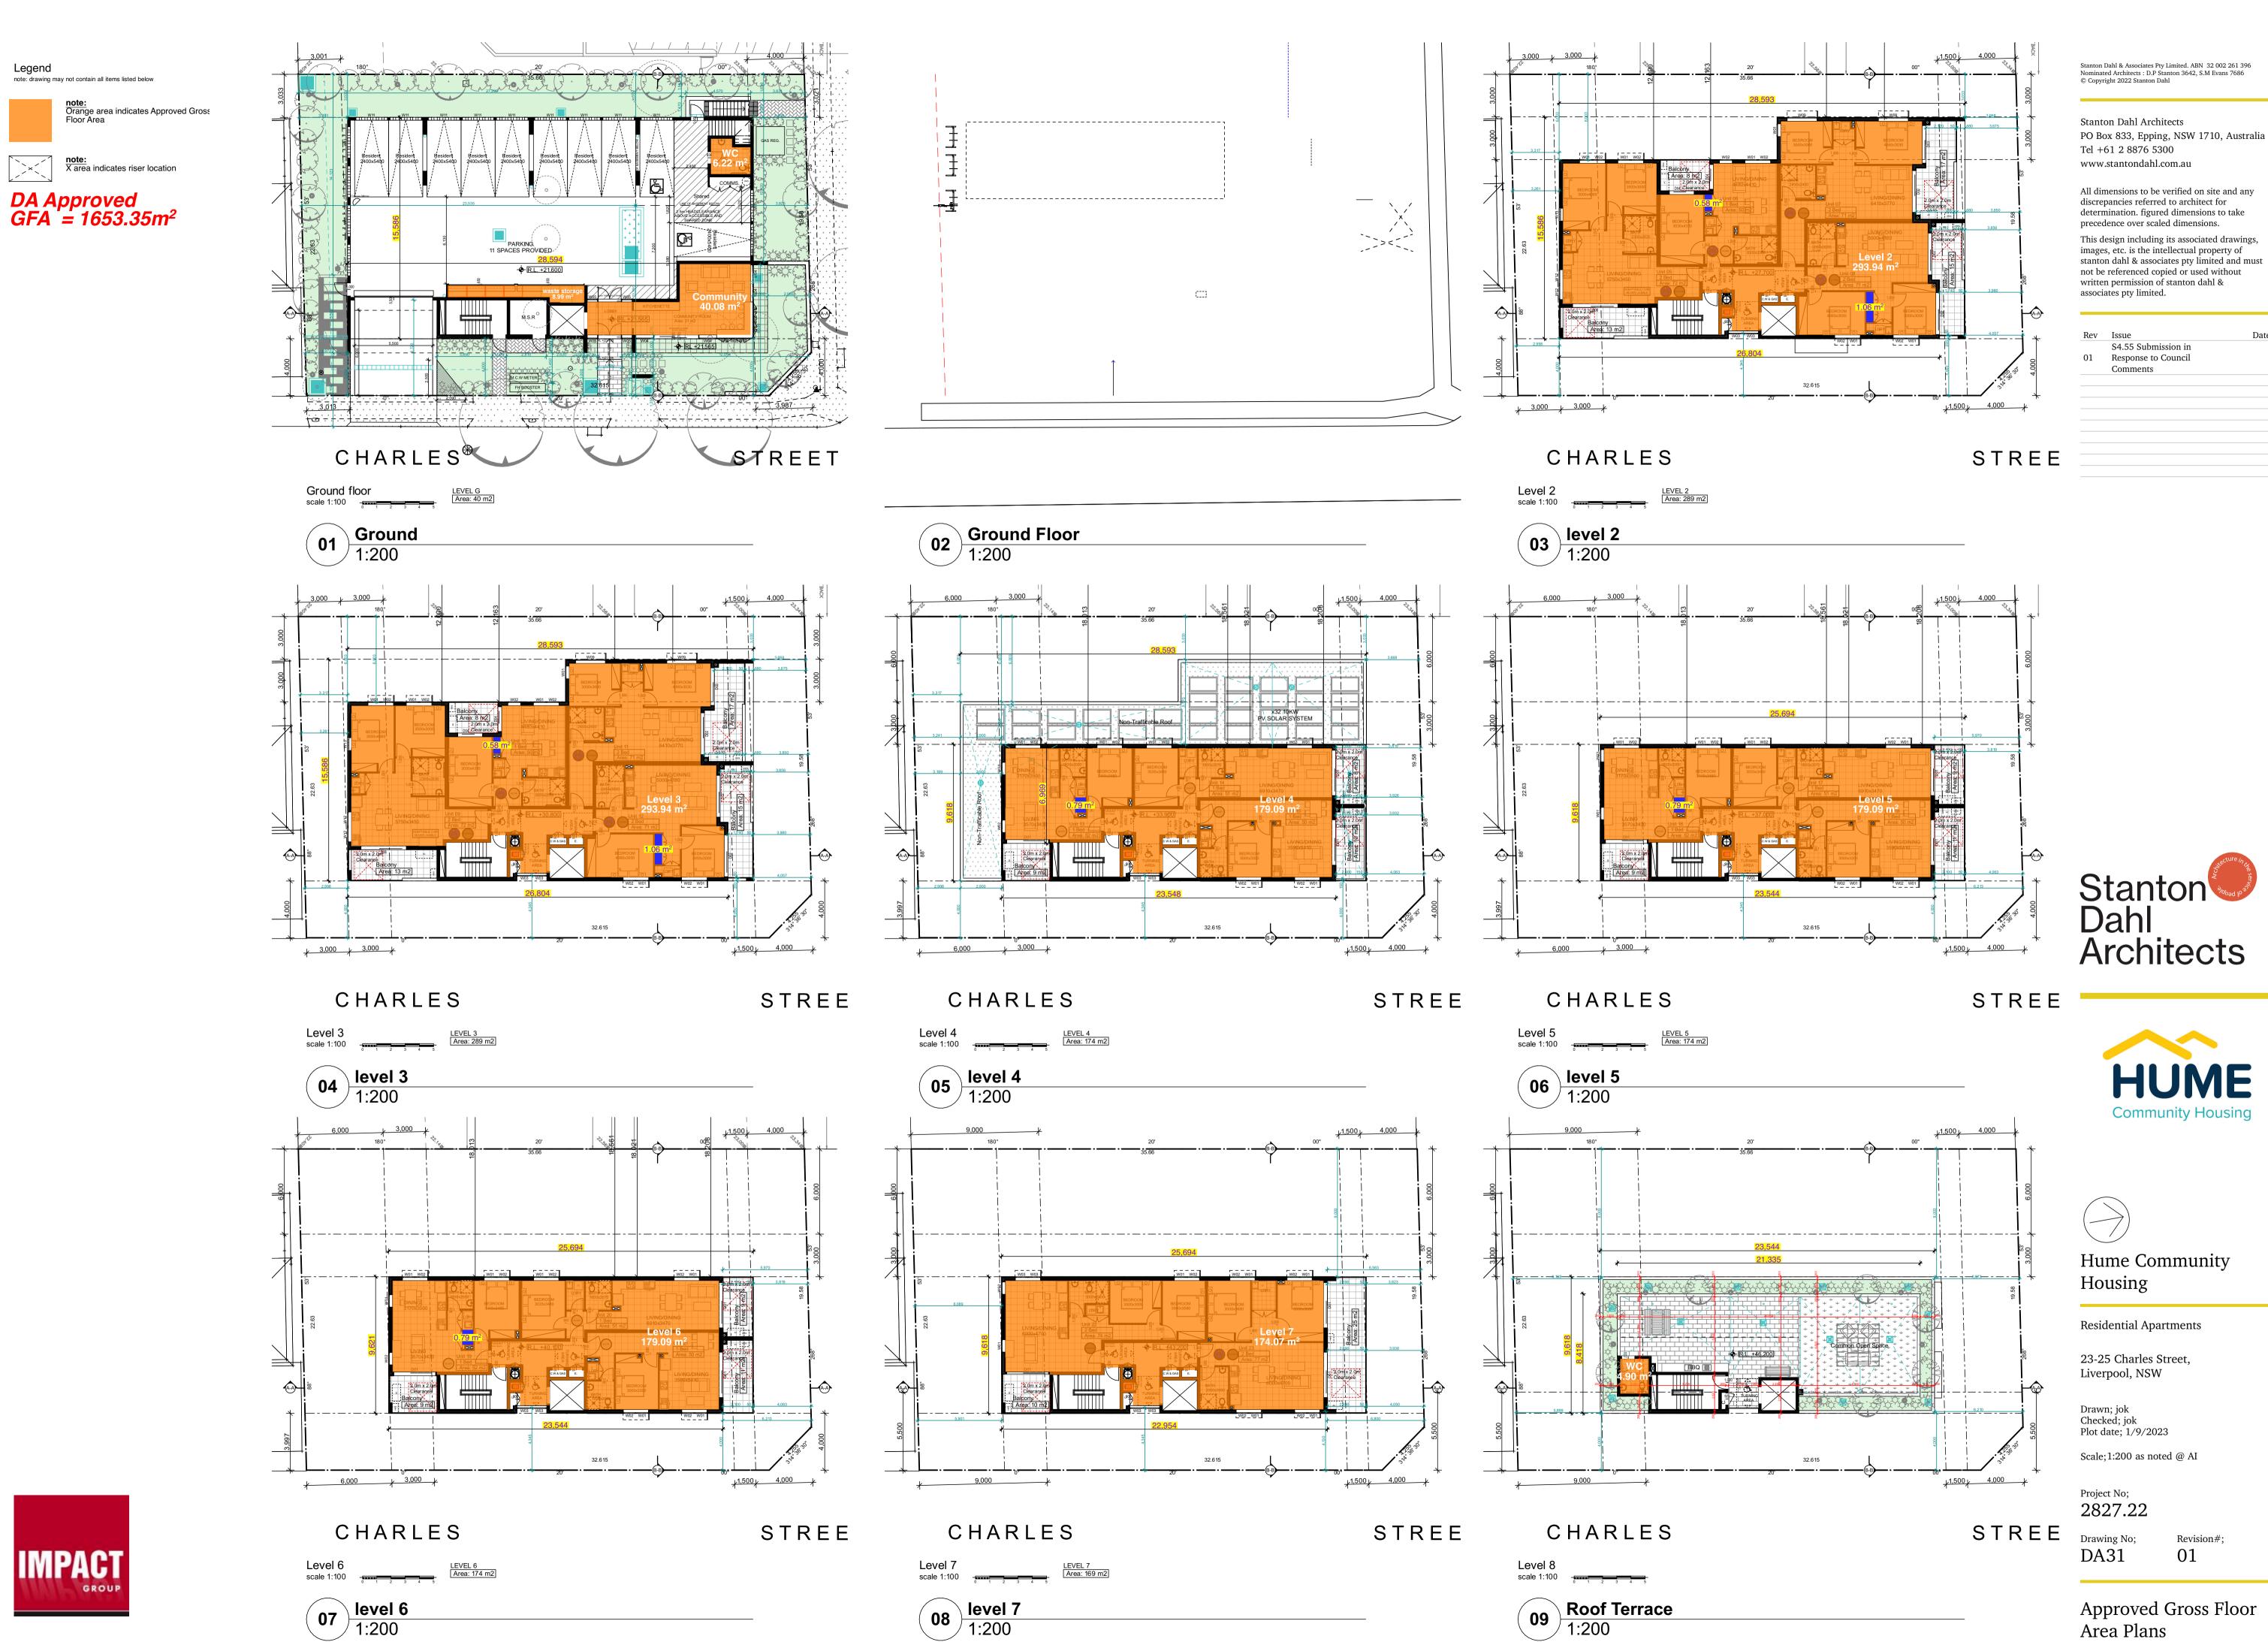


Revision#;



note: Pink area indicates Proposed Building Footprint Area

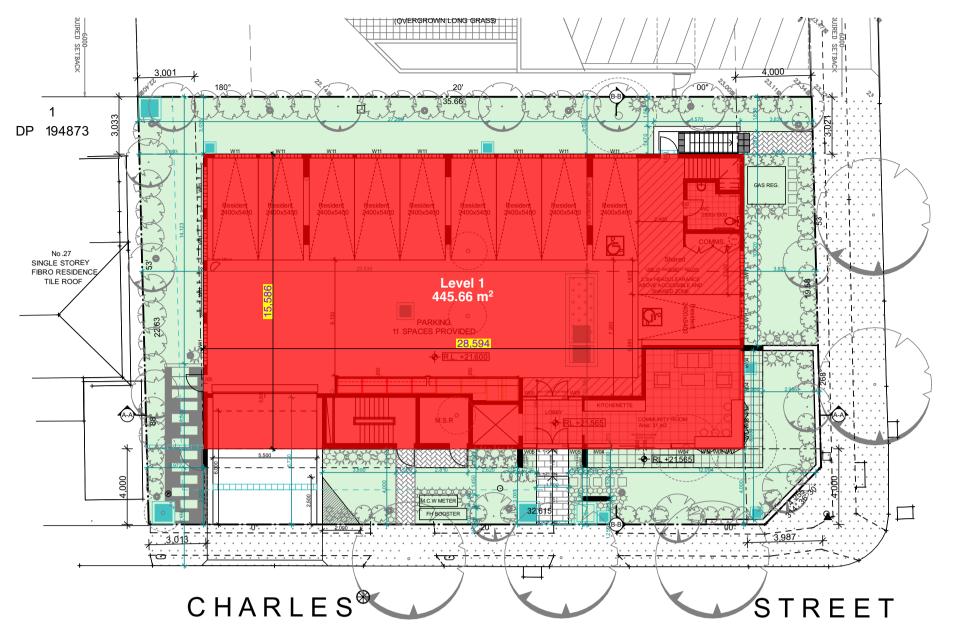

Existing Building Footprint Plan
1:200

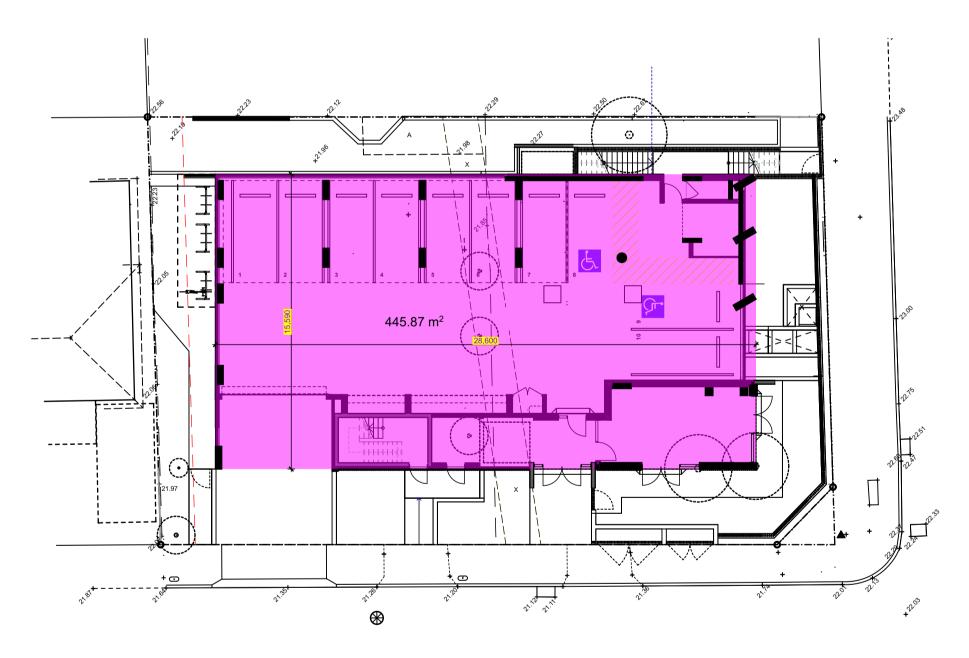

01 Proposed Building Footprint Plan
1:200



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S4.55 Submission in 01 Response to Council

Comments







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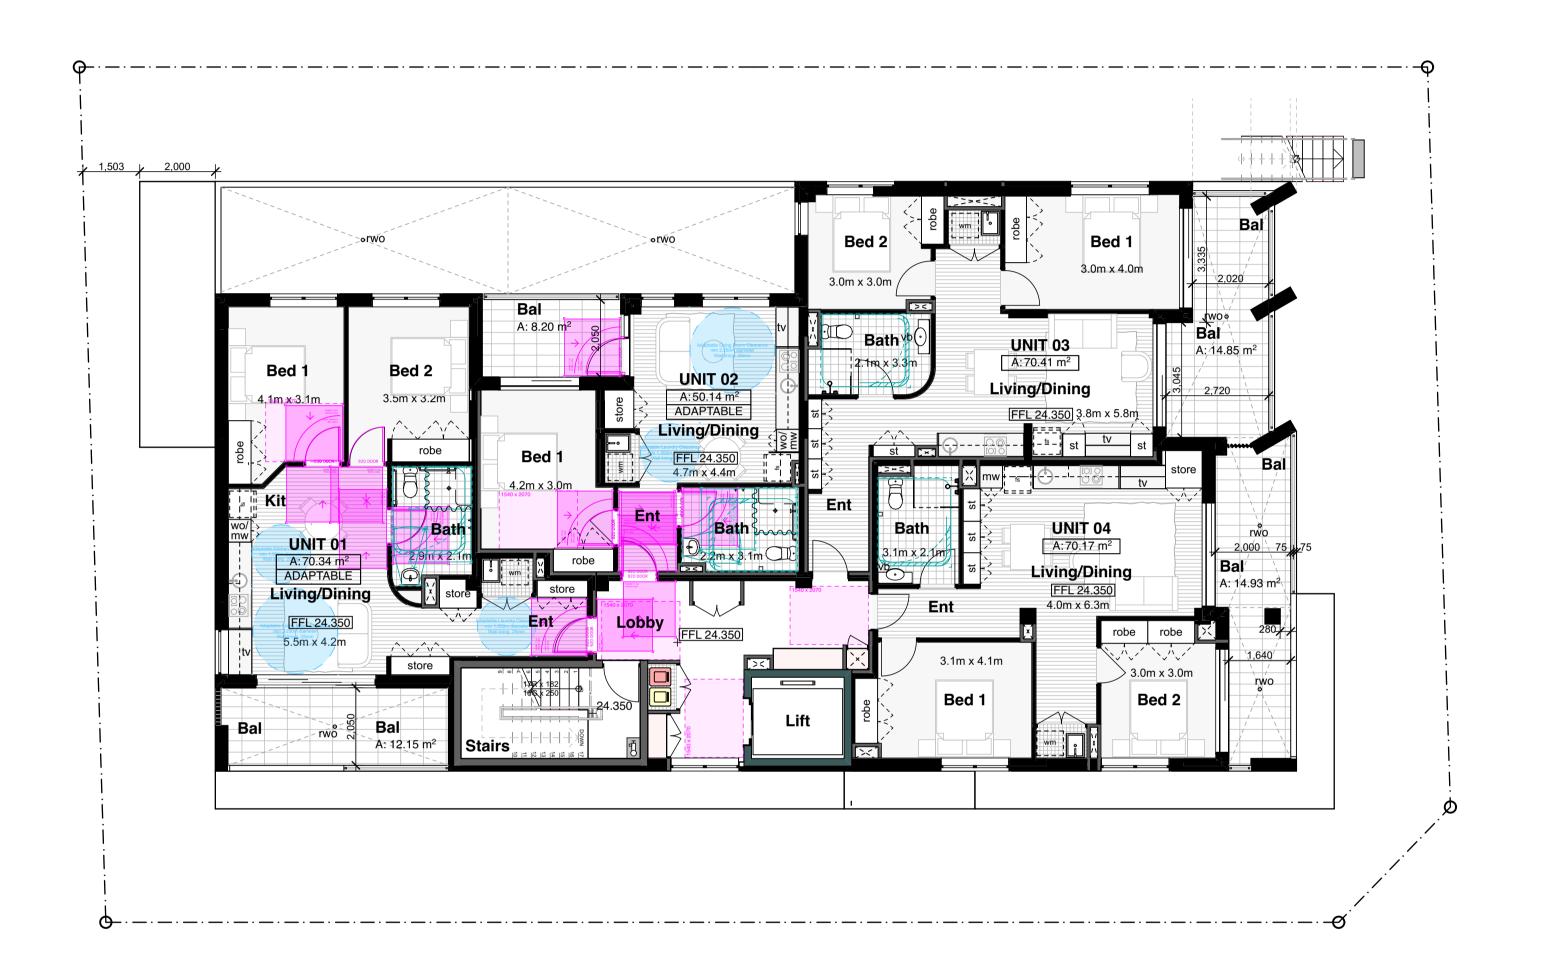
Project No; 2827.22

Drawing No; DA32

01

Revision#;

Building Footprint Plans





Legend (floor plans)
note: drawing may not contain all items listed below

door numbers (as scheduled) (prefix ex. for existing door)

window numbers (as scheduled) (prefix ex. for existing window)

wall type (as scheduled)

ageing, disability & home care ambulant access panel bal(1) balustrade (type) broom finish concrete

bol bollard broom cupboard cft(1) ceramic floor tile (type) control joint clothes line column

communication cabinet cooktop downpipe doorpost electrical distribution box

face brickwork (type)

fire hose reel

fridge space

feature panel

floor mat

floor waste garbage bin gate grated drain hr(1) handrail (type) hose tap hot water unit hydrant kerb ramp letter box linen cupboard

off form concrete permeable paving privacy screen robe wardrobe rw(1) retaining wall (type) rainwater tank sink steel column steel float concrete shower skylight/skytube

sliding door sheet vinyl (type) storm water pit tactile ground surface indicators vent pipe wood float concrete washing machine space

wall oven

wheel stop

window casing

UNIT 06——•Unit number A:50.00 m² Unit total area

AFFORDABLE - LHA S Unit type *LHA S refers to Livable Housing Australia - Silver Level Stanton Dahl & Associates Pty Limited. ABN 32 002 261 396 Nominated Architects : D.P Stanton 3642, S.M Evans 7686 © Copyright 2022 Stanton Dahl

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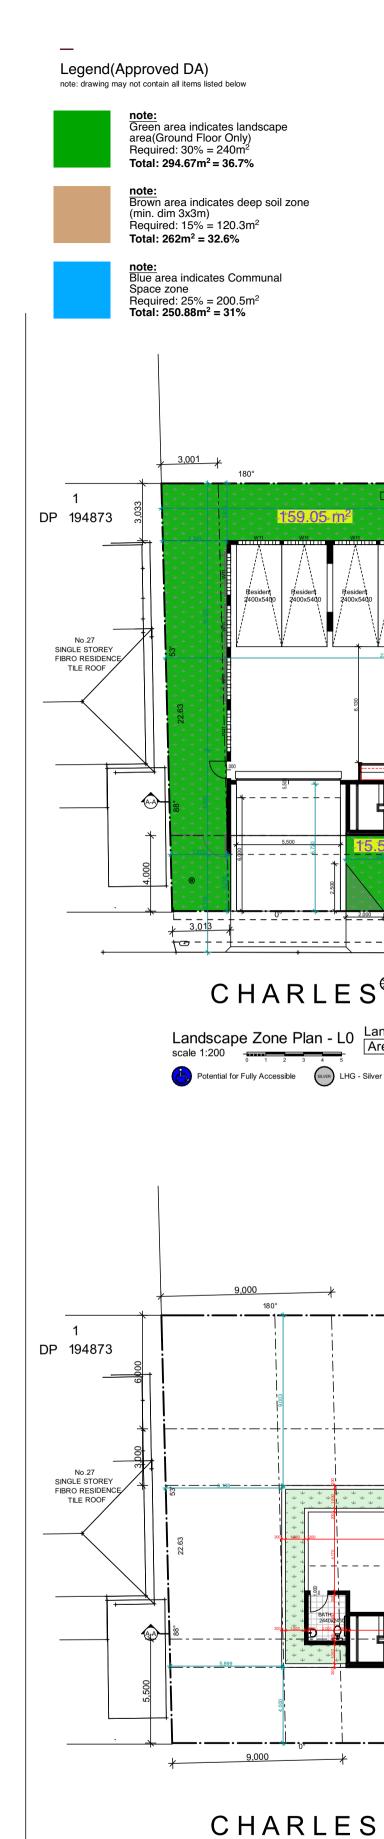
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Project No; 2827.22

Drawing No; DA33 01


Adaptable(Access) Plan

Revision#;



Landscape Zone Plan - L8 Scale 1:200 Area: 49 m2

Potential for Fully Accessible LHG - Silver level LHG - Platinum level

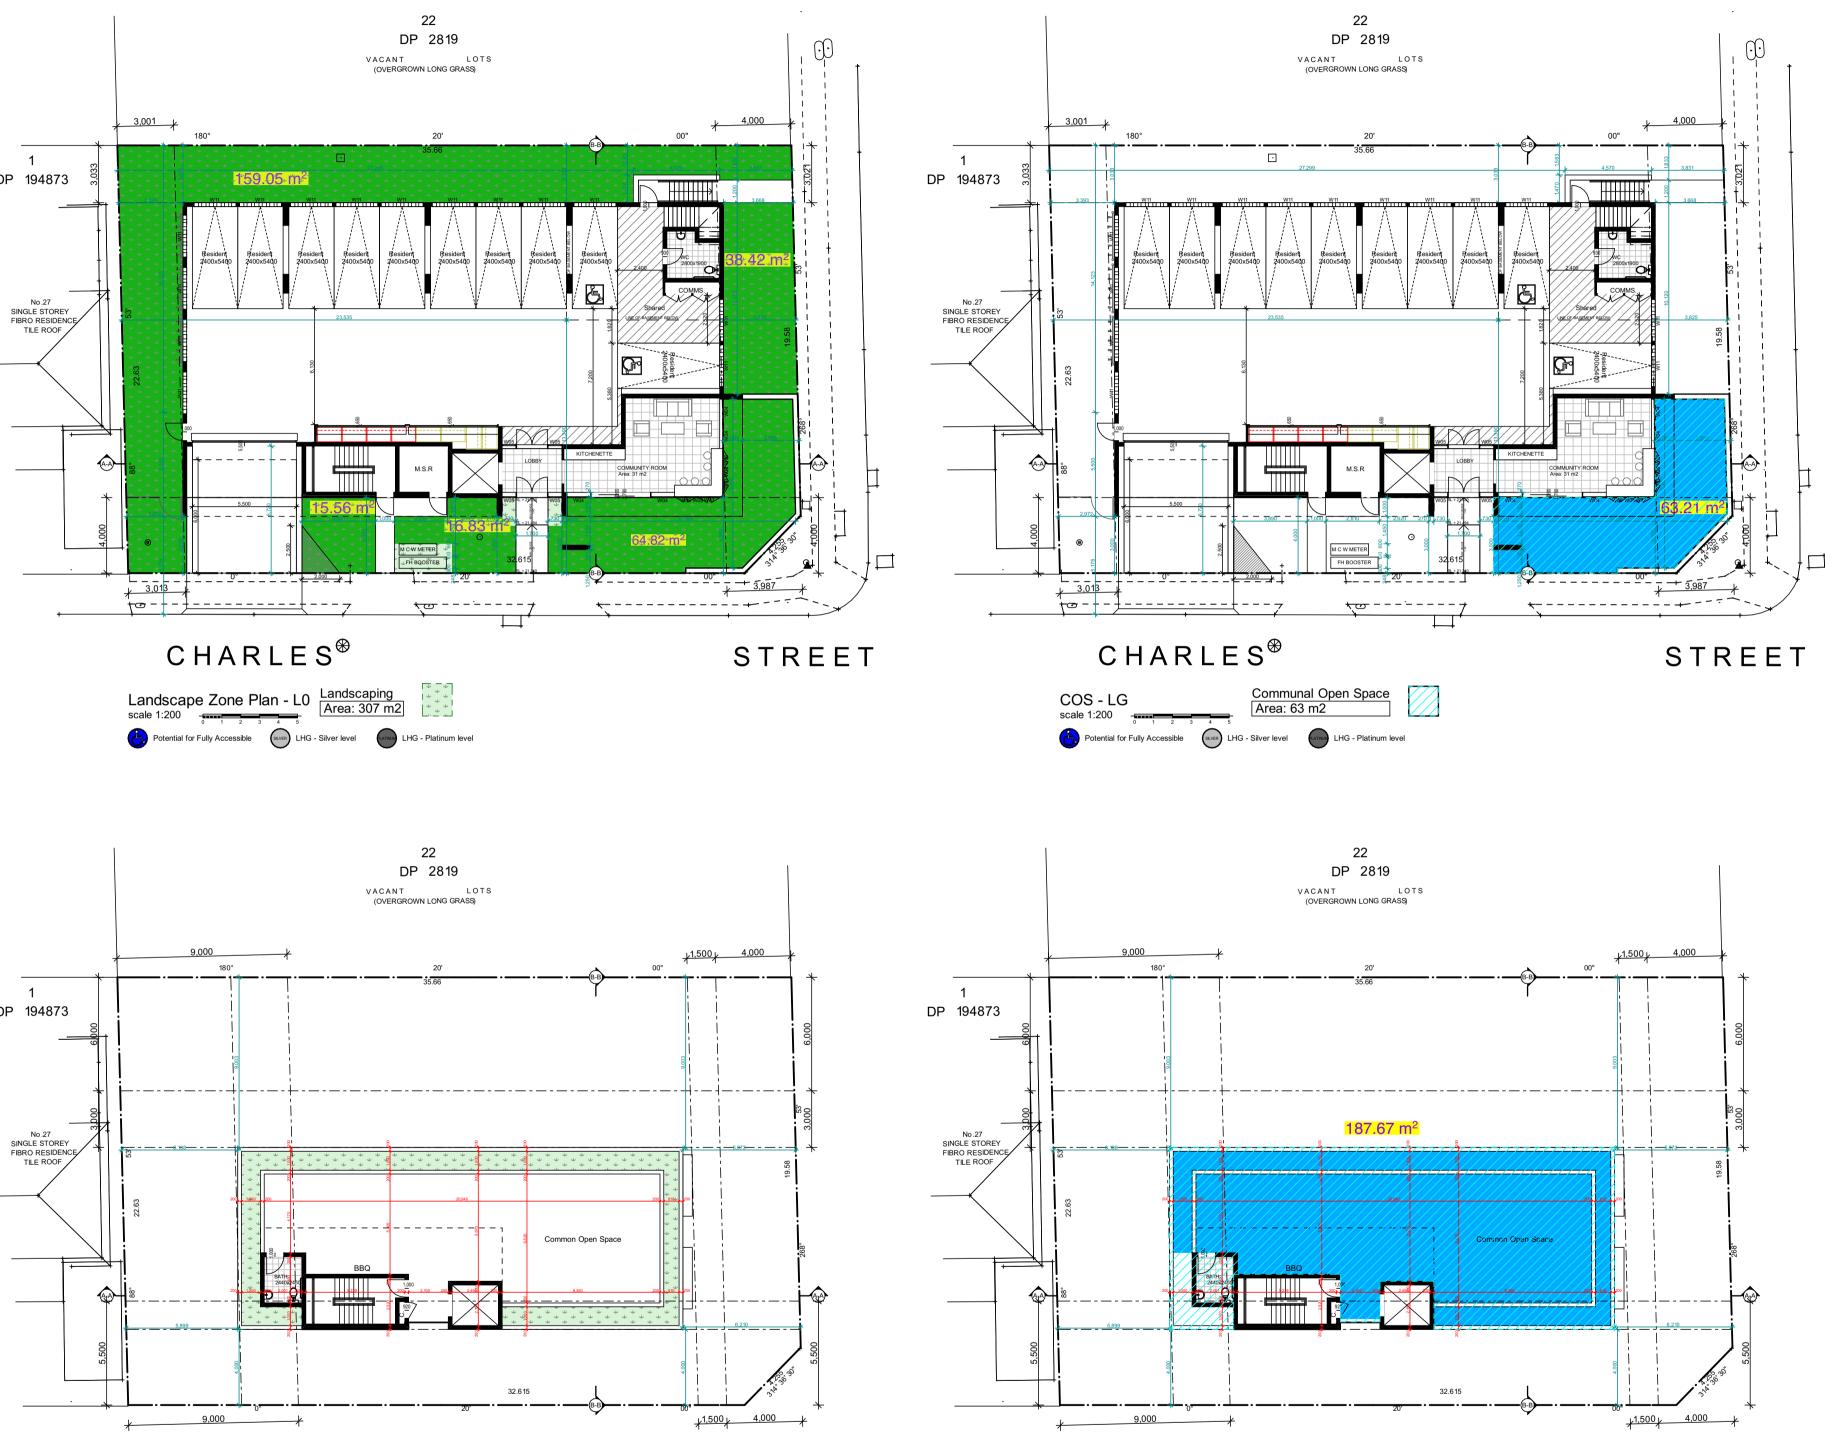


STREET

CHARLES

Potential for Fully Accessible Super LHG - Silver level LHG - Platinum level

STREET

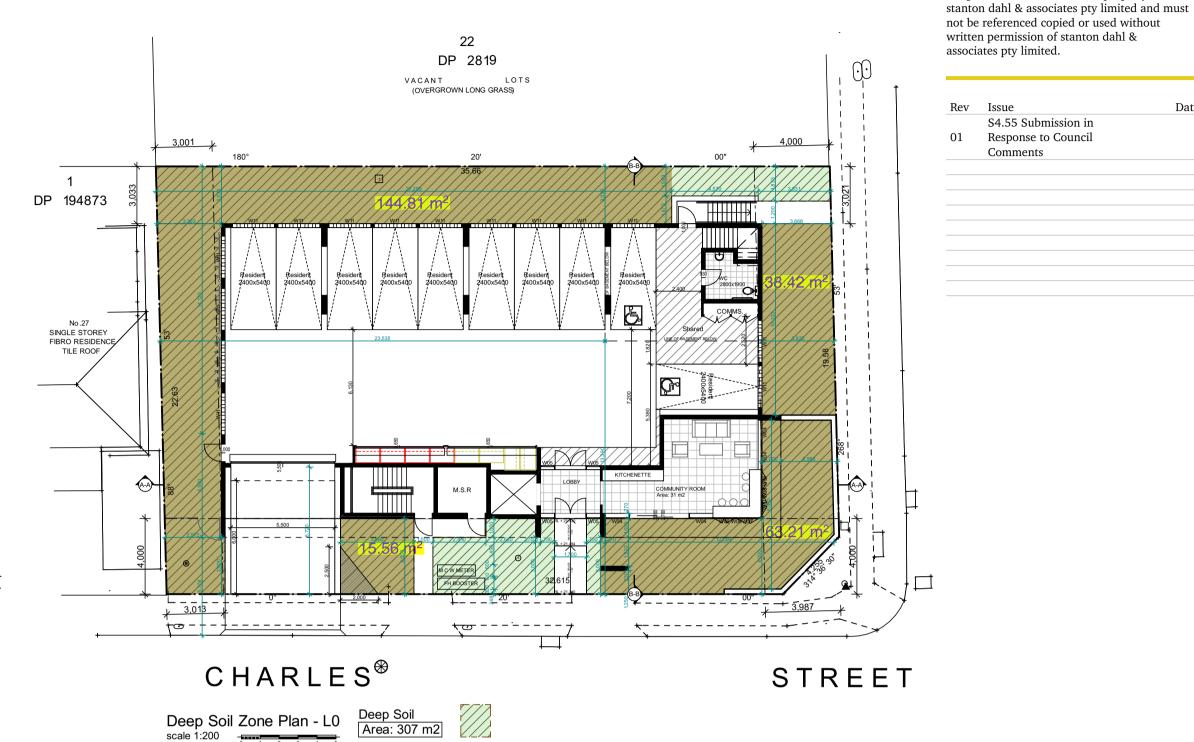

Potential for Fully Accessible LHG - Silver level LHG - Platinum level



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Drawing No; Revision#; DA34 01

ADG - Approved Area Calculations